

Village of Hinsdale 19 E. Chicago Avenue Hinsdale, IL 60521-3489 (630)789-7000 Village Website: www.villageofhinsdale.org

PUBLIC SERVICES UTILITY PERMIT APPLICATION

Date of Application: 01.28.21 Permit No: Nicon-oog	Permit Expiration Date: 07-31-2/
Utility Company Information:	Contractor Information:
Company Name: NICOR GAS	Company Name: PIPE STRONG
Address: 257 COMMERICAL DRIVE	Address: 1901 N. ROSELLE, STE 826
City, State, Zip: YORKVILLE, IL 605	City, State, Zip: SCHAUMBURG, IL 60195
Contact Person: CATHY LABARBERA	Contact Person: MIKE BOYD
Phone Number: 630 385.3148	Phone Number:
Email Address:	Fmail Address:
	Email Address: Cell Number: 224 301.5977
Project/Work Order Number: 150689	
PROJECT LOCATION: 5500 S. Grant Street Description of work covered under this permit:	
TO INSTALL APPROX 181' - 4" PE, TO SERVE 55th STREET AND GRANT STREET	
Start Date: TBD	Completion Date:
Site Plan/Details/Specifications (3 sets) included with application Certificate of Insurance included with application?	n? O YES O NO O YES O NO
Type of Utility: ComEd Nicor Communications: Fiber Optic	Comcast Water Sewer Wireless Other:
Applicant Information:	
Print Name: CATHY LABARBERA	Phone Number: 630 385.3148
Company: NICOR GAS/SOUTHERNCO	Email Address: CLABARB@SOUTHERNCO.COM
Signature:	Date: 01.28.21
ALL CONSTRUCTION SHALL BE DONE IN ACCORDANCE WITH THE LATE THE FOLLOWING: STANDARD SPECIFICATIONS FOR ROAD AND BRIDGE RECURRING SPECIAL PROVISIONS BY THE ILLINOIS DEPARTMENT OF T CONTROL DEVICES FOR STREETS AND HIGHWAYS, STANDARD SPECIFILLINOIS, AND THE VILLAGE OF HINSDALE SUBDIVISION ORDINANCE AND	ECONSTRUCTION & SUPPLEMENTAL SPECIFICATIONS AND FRANSPORTATION, ILLINOIS MANUAL ON UNIFORM TRAFFIC FICATIONS FOR WATER AND SEWER MAIN CONSTRUCTION IN
Village Us	e Only
Permit Approved: YES NO	
Conditions for Approval/Reasons for Denial: RESTORE A DA-15 OF INSTACLATION. PROVIDE O AND HIGH SCHOOL DIST. 86 PRIOR	TO START
Approved By: A. Dia 2	Date: 02-10-2/

- GENERAL NOTES

 1. CONTRACTOR TO INSTALL THE PROPOSED GAS MAIN TO THE ELEVATIONS SHOWN ON THE PLANS USING THE BENCHMARKS PROVIDED APPROXIMATE COVER SHOWN AFTER THE REQUIRED ELEVATION IS FOR INFORMATION PURPOSES ONLY.

 2. BACKFILL WITH SAND WHERE PIPE TRENCH IS UNDER OR WITHIN 2' OF PAVEMENT, CURB, OR SIDEWALK.

 3. INSTALL PROPOSED MAIN USING ROAD STATIONING WHERE GIVEN. OTHER DIMENSIONS ARE FOR MAPPING PURPOSES ONLY.

 4. ALL RIGHT-OF-MAY MUST BE STAKED AND STATIONING PROVIDED BEFORE GAS MAIN CAN BE INSTALLED.

 5. INSTALL PIPELINE MARKERS PER GCS 249. SEE SPECIFICATION FOR ALL REQUIREMENTS, FOR CLASS 1 AND 2 LOCATIONS, MARKERS ARE REQUIRED AT ALL RAILROAD AND WATERWAY CROSSING.

 6. INSTALL PIPELINE MARKERS PER GCS 249. SEE SPECIFICATION FOR ALL REQUIREMENTS, FOR CLASS 1 AND 2 LOCATIONS, PIPELINE MARKERS ARE REQUIRED AT ALL RAILROAD AND WATERWAY CROSSING.

 7. PIPELINE MARKERS ARE REQUIRED AT ALL RAILROAD AND WATERWAY CROSSING.

 8. INSTALL ALL MAIN WITH A MINIMUM COVER OF 3' UNLESS OTHERWISE NOTED.

 9. PIPE CONTRACTOR SHALL INSTALL THE PROPOSED GAS MAINS CROSSING CONCRETE, ASPHALT, MACADAM, OR OTHER HARD SUFFACED PAVEMENTS, WALKS, OR DRIVEWAYS BY BORNING OR PUSHING UNLESS OTHERWISE SPECIFIED, CONTRACTOR WILL INSTALL A TEMPORARY PATCH PER GAS CONSTRUCTION SPECIFICATIONS FOR CONTRACTORS. PERMANENT REPAIRS TO BE CONTRACTOR SHALL FURNISH AND INSTALL ALL CAPS AND OTHER FITTINGS NECESSARY FOR TESTING THE MAIN.

 9. ALL 8' AND LARGER STEEL PIPE THAT IS BORED MUST BE DUAL COATED.

 10. PLUG AND/OR CAP RETIRED 6' AND LARGER MAINS EVERY 660' PER GCS 849.

 11. RETIRE OLD MAIN PER GCS 849.

 12. IT IS THE RESPONSIBILITY OF THE INCOR GAS INSPECTOR, CONTRACTOR, AND ANYONE INVOLVED IN THE CONSTRUCTION OF THE FACILITIES TO FOLLOW THE LATEST NICOR GAS GMS AND GCS SPECIFICATIONS. CONTACT NICOR'S TECHNICAL SERVICES DEPARTMENT FOR A COPY OF THE LATEST PRIOR TO STRUCTURES.

 13. COORDINATE WITH NICOR GAS INSPECTOR FOR LOCATION OF UNDERGROUND UTILITIES PRIOR TO STACTIONALLY BORDED PIPE TO BE INSTALLED PER NICOR GAS DIRECTIONALLY BORDED PIPE
- CONTACT INFO: NICOR GAS

NGUYEN, CALVIN (DESIGN ENGR.) PHONE: (630) 388-3747

NICOR GAS RAYMOND, ROB (CON-OPS SUPT.) PHONE: (815) 261-9433

ENVIRONMENTAL NOTES:

- VIRONMENTAL NOTES

 PCB WIPE SAMPLES, PERFORMED BY NICOR GAS EMPLOYEES, ARE REQUIRED FOR ALL 4" AND LARGER PIPE THAT IS ABANDONED OR REMOVED ON THIS WORK ORDER. DIRECT OUESTIONS ON PCB WIPE SAMPLE PROCEDURES TO THE SYSTEM OPERATIONS DEPARTMENT OR KEITH BODGER (630-514-7589) IN ENVIRONMENTAL AFFAIRS (EA).

 COLLECT AND PROPERTY DISPOSE OF ALL LIQUIDS FROM PIPELINES BEING RETIRED.

 IN THE EVENT OF A SPILL, PLEASE IMMEDIATELY CALL DISPATCH (630-317-9111) AND ASK FOR THE ON-CALL ENVIRONMENTAL REPRESENTATIVE.

 ANY RETIRED PIPE THAT MUST BE REMOVED FROM THE SITE SHOULD HAVE THE ENDS COVERED WITH PLASTIC OR SIMILAR MATERIAL UNTIL THE PIPE WIPE SAMPLE LAB RESULTS ARE KNOWN. INDICATE ON THE "NICOR GAS PCB SAMPLE INFORMATION FORM." WHERE ANY PIPE REMOVED FROM THE SITE IS BEING TEMPORABILY LOCATED.

 IF ASBESTOS COAL WRAP IS IDENTIFIED, REFER TO ASBESTOS COAL TAR WRAP REMOVAL GUIDELINES. REMOVAL MUST BE COMPLETED BY A TRAINED EMPLOYEE, FOR ANY OUESTIONS OF PROCEDURE OR TRAINED EMPLOYEES, CALL SCOTT MURPHY (630-392-7033) IN THE SAFETY DEPT.

 IF CONTAMINATED SOIL IS SUSPECTED, CALL KEITH BODGER (630-514-7589) IN EA FOR REQUIATORY COMPLIANCE INSTRUCTION.

 ALL WETLANDS SHOULD BE IDENTIFIED ON THESE WORK ORDER DRAWINGS. WETLANDS AND WATERBODIES ARE GENERALLY LABELED AS "SITES." IF THERE IS A QUESTION ABOUT THE WETLAND BOUNDARIES OR BUFFERS, PLEASE CALL EA (JUDILE)

- ALL METANUS AND METANUS AND METANUS AND METANUS METANUS AND WATERIAL AND METANUS AND WATERIALS AND GENERALLY LABELED AS "SITES." IF THERE IS A QUESTION ABOUT THE WEILAND BOUNDARIES OR BUFFERS, PLEASE CALL EA (JULIE PASCHAL AT 630-392-7013 OR ALICIA BISHOP 224-268-7283).

 IF THE PROJECT HAS ENVIRONMENTAL PERMITS AND/OR A GREEN BINDER, THE CONTRACTOR IS RESPONSIBLE FOR FOLLOWING THE NICOR GAS STORM WATER POLLUTION PREVENTION PLAN FOR THE PROJECT. IF THERE ARE QUESTIONS, PLEASE CALL EA (JULIE PASCHAL AT 630-392-7013 OR ALICIA BISHOP 224-268-7283).

 IF A FRAC OUT OCCURS DURING DIRRECTIONAL DRILLING, THE CONTRACTOR IS RESPONSIBLE FOR STOPPING THE BORE.

 CONTAINING THE FRAC OUT MATERIAL, AND IMMEDIATELY CONTRACTOR IS RESPONSIBLE FOR STOPPING THE BORE. BISHOP 224-268-7283). AFTER CONTAINING THE MATERIAL AND CONTACTING EA, THE CONTRACTOR MUST REMOVE THE FRAC OUT MATERIAL.

- OUT MATERIAL

 10. REFUEL AND STORE EQUIPMENT A MINIMUM OF 100 FEET FROM WETLANDS OR WATER BODIES.

 11. INSTALL SOIL AND EROSION CONTROL PROTECTION TO PROTECT ANY OPEN GRATED STRUCTURES, I.E. INLETS, CATCH BASINS, OR MANHOLES WITHIN OR ADJACENT TO THE PROJECT AREA THAT ARE NEAR DISTURBED SOIL.


 12. WHEN DEWATERING, DIRECT WATER TO A FLAT, UPLAND AREA TO ALLOW WATER TO SOAH INTO THE GROUND AND/OR USE FILTER BAGS AND WOOD FIBER LOGS TO REMOVE SOIL/SEDIMENT FROM THE WATER, NO SEDIMENT LADEN WATER IS ALLOWED TO ENTER INLETS, WETLANDS, WATER BODIES, ETC.

 13. IF MUD IS BEING TRACKED ON THE STREETS BY EQUIPMENT AND/OR VEHICLES, DAILY STREET SWEEPING WILL BE REQUIRED.

 14. ALL DISTURBED AREAS SHALL BE RESTORED TO ORIGINAL CONTOURS AND CONDITIONS. RESTORATION MUST BE INITIATED WITHIN 1 DAY DEPENDING ON PERMIT CONDITIONS.

REQUIRED PERMITS APPROVAL BEFORE CONSTRUCTION	REQUIRED	APPROVED DATE
LAND SERVICES-APPROVAL		
RAILROAD		
HIGHWAY, STATE		
HIGHWAY, COUNTY		
FOREST PRESERVE		
SANITARY DIST.		
PRIVATE PROP. EASEMENT		
FRONTAGE		
OTHER GOV. AGENCY		
ENVIRONMENTALAPPROVAL		
WATERWAYS		
WETLANDS		
CONTAMINATED SOIL		
STORM WATER		

NICOR GAS - CONSTRUCTION NEW BUSINESS FOR NBA1846049 55TH ST AND S GRANT ST HINSDALE, IL W.O.# 150689/350689 (SERVICE) W.O.# 150688/350688 (METER)

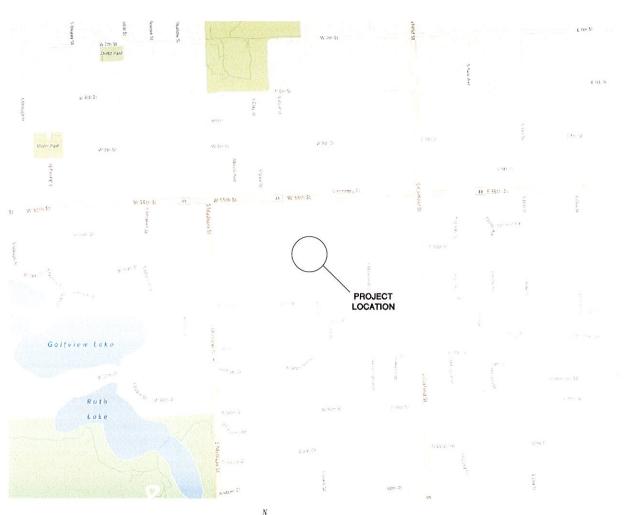

LOCATION MAP

811

	IDENTIFIED B	Y NICOR UTILITY INS	PECTOR			COMPLETED BY NICOR GAS*
WIPE TEST #	WORK ORDER PAGE	TEST LOCATION	PIPE SIZE	PIPE MATERIAL	DATE TEST COMPLETED	COMMENTS

DRAWING - SHEET DESCRIPTION WC21131A - 1

COVER PAGE

*TYPICALLY COMPLETED BY UTILITY INSPECTOR


NOTE
NICOR UTILITY INSPECTOR TO IDENTIFY TEST LOCATIONS BASED UPON THE CRITERION OF ONE TEST FOR EACH
"CUT AND CAP" ON PIPE THAT MEASURES FOUR INCHES IN DIAMETER OR GREATER. NICOR GAS UNDERSTANDS
THAT FIELD PERSONNEL MAY DECIDE TO MOVE "CUT AND CAP" LOCATIONS, DELETE "CUT AND CAPS", OR
CONDUCT ADDITIONAL "CUT AND CAPS". NICOR GAS WILL INCLUDE WIPE TESTS AS PART OF THEIR ROUTINES
TO COMPLETE A "CUT AND CAP" AND IT IS THE RESPONSIBILITY OF NICOR GAS TO ASSURE THAT NECESSARY
WIPE TESTS ARE CONDUCTED AS REQUIRED
BY FEDERAL REGULATIONS.

SERVICE REPLACEMENT FOR NEW BUSINESS

By JERJAMES at 4:08 pm, Jan 13, 2021 ICENSE EXPIRATION: 🔼 Nicor Gas

APPRO	WE	D E	ΛP		COUNTY DUPAGE	TOWNSHIP DOWNERS GROVE	1/4 SECTION 131			
	10000		~		TOWN HINSDALE	TIER RANGE T38N R11E	3РМ			
CONST	ΓRU	CTI	ON		REGION DEPARTMENT ENGINEER/DESIGNER DATE CENTRAL CONSTRUCTION C. NGUYEN 05/					
					WORK ORDER NO. 150689/350689	DRAWN BY C. NGUYEN	DATE 05/26/2020			
					NICOR JOB NO. NODE/ NBA1846049	J. GRECO	DATE 06/01/2020			
						CORROSION D. SMITH	DATE 06/02/2020			
		-			SCALE N.T.S.	APPROVED BY	DATE 1/13/2021			
DESCRIPTION	BY	CHK'D BY	APP'D. BY	DATE	DATE IN SERVICE	DRAWING FILE P				

TOTAL WORK ORDER QUANTITIES								
TOTAL PIPE INSTALLATION	ESTIMATED	ACTUAL						
4" PE IPS SDR 11.5	138'							
TOTAL PIPE RETIREMENT	ESTIMATED	ACTUAL						
4" STEEL SERVICE	96'							
4" STEEL (1970)	77'							
TOTAL TRENCH BACKFILL	12 CY							
TOTAL ASPHALT & CONCRETE BREAKS	100 SF							
TOTAL SERVICE TRANSFERS	1							

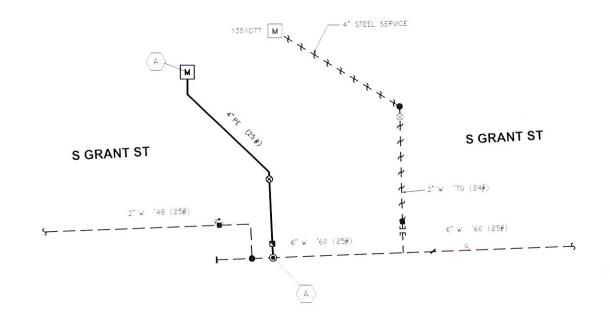

N	
sk	SITE PLAN
74	(NTS)

TEST	SEC	HOIT	DE	SCR	IPTION	l	LEAK 7	TEST P	ER GCS	887		STR	ENGTH	TEST F	PER GC	S 888		WELD INS	SPECTION PER	R GCS 851	FI	ELD R	ECORD PER GCS 860
SECTION	мор	TYPE	TOTAL LENGTH	DIA	MAT'L	PAGE	TEST PRESSURE (PSI)	PRIOR TO STRENGTH	COMB W/ STRENGTH	MIN HOURS	TEST PRESSURE (PSI)	% SMYS PIPE	AT TEST FITTINGS	TEST AIR/N2	WATER* (GALLONS)	ALLOWABLE △P (PSI) (>60# SYS)	MIN	VISUAL	RADIOGRAPHIC (%)	OTHERS	SECTION	DIA	PIPE IDENTIFICATION "DATA CODE"-STEEL MAIN ONLY
(<u>A</u>)	60	1	138'	4"	PE	3	90	1-0		1		-	-	· - :	-	-	1-	X	-		(A)	4"	

	SYMBOL LEGEND
T	PURGE END (GCS 209/709)
94	ANODE (GCS 513/514)
•	LATERAL TEE/HIGH VOLUME TEE (GCS 210 21-33, 720, 720
• -	PRESSURE CNTL FTG. (GCS 210.38/.39)
•	TRANSITION FITTING (GCS 703)
⊗ .	VALVE - GENERAL
+	REDUCER (GMS 308 & 336)
•	INS. COUPLING (ECT)
Ū	TIN WHISTLE (GMS 639.2, 3. 4)
¥	DUAL 6' X 5' VAULT
岩	CUT AND CAP (GCS 849)
4	RETIRE MAIN (GCS 849)
車	EXCAVATE AREA (GCS 870)
\odot	TREE
#	INSULATOR FLANGE
•—	ELECTRICAL TEST STATION
R	REGULATOR STATION
	BORE PIT/TAP HOLE & SPOIL PILE W/SILT FENCE
	SITE LOCATION
•	COUPLING
M	METER SET

								PREPARED BY	Ni	cor Ga	S
	APPRO	\/E	ח	= 1	7	,		COUNTY DUPAGE	Townshi DOWN!	RS GROVE	1/4 SECTION 131
	APPRO	٧L	ו ט	-(JF	١		TOWN HINSDALE	TIER T38N	RANGE R11E 3PM	
	CONST	RU	CT	10	1C	1		REGION DEPAR	RTMENT ISTRUCTION	ENGINEER/DESIGNER C. NGUYEN	DATE 05/06/2020
		T		T		T		WORK ORDER NO. 150689/350689		DRAWN BY C. NGUYEN	DATE 05/26/2020
-		+		-		-		NICOR JOB NO. NOD NBA1846049	DE/LD NO.	CHECKED BY J. GRECO	DATE 06/01/2020
										CORROSION D. SMITH	DATE 06/02/2020
				+		-		SCALE N.T.S.		APPROVED BY	DATE 1/13/2021
REV.	DESCRIPTION	BY	CHK'D	BY	APP'D.	BY	DATE	DATE IN SERVICE		DRAWING FILE NO. WC21131A -	SHEET 2 OF 5


82-1/4" OF THE INTERCHANGEABLE ITEMS OR DESIGN CRITERIA, CONSULT ENGINEERING FOR APPROVAL 51-5/8" 30-5/8 0 14)43

METER SIDE VIEW

97-7/8" (43)(42)(33)-

REGULATOR SIDE VIEW

CONNECTIONS.

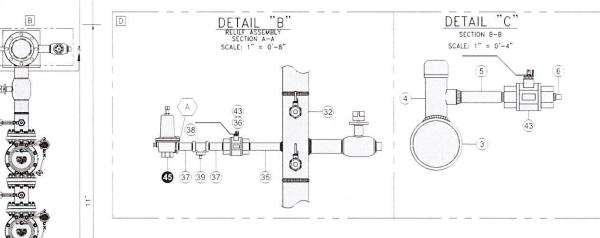

		SCALE:	1" = 0'-4 TO RE	GULATOR BYF	ASS
	<u>27</u> —				— <u>(27)</u>
TO METER BYPASS					
TO METE					

		NOTES						
Α	NICOR	GAS SERVICE ENDS WITH 4" - ANSI 300 WELD NECK FLANGE.						
В	CUSTOMER'S FUEL LINE TO START WITH 6" - ANSI 150 WELD NECK FLANGE. SEE GCS 602 FOR CHECK VALVE APPLICATION.							
С	10'-0"	x 11'-0" x 6" THICK REINFORCED CONCRETE PAD.						
	VENTIN	IG - IF INSIDE METER SET:						
	1.	INSTALL SEPARATE VENT LINE FOR EACH REGULATOR EXTENDED OUTDOORS WITH A VENT CAP.						
D	2.	INSTALL SEPARATE LINE FOR RELIEF EXHAUST EXTENDED OUTDOORS WITH A VENT CAP.						
	3.	DO NOT MANIFOLD THE REGULATOR VENT LINE & EXHAUST LINE.						
	4.	VENT TO SAFE LOCATION (SEE GCS 400 & 401, SEC.8). IF VENT EXCEEDS 10' - SEE APPENDIX 1.						
E		URE METERING: CONTACT THE MEASUREMENT DEPARTMENT FOR IMMENTATION REQUIREMENTS.						
-	SERVIC	E RISER TO INCLUDE LARGE TAP FOR TEMPORARY INLET BYPAS						

UPSTREAM LINE MOUNTED 38M/56M 4" REGULATORS 6" TOP OUTLET (OP/MNTR)

BILL OF MATERIALS

	QUANTITY	STORES ITEM	SIZE	ITEM DESCRIPTION	RATING	GN
1	1	NO.	4"	FLANGE LAP JOINT ANSI 300 FORGED STEEL	740	43
1		559450.N		STUB END LAP JOINT WELD-END Y-52 STEEL 0.237" WT	2738	33
2	1	558237.N P.O.	4" x 6"	PIPE X-52 STEEL BARE 0.237" WT	2738	120
3 4	1 1	620321.N	4" x 6" 1"	SERVICE TEE WELDED MUELLER H-17656	1440	120
	8	558004.N	3/4" x 4"	NIPPLE PIPE THREADED ONE END MNPT SCH. 80 EX-HVY STEEL	510	316
5			3/4 × 4	METER VALVE THREADED FNPT WKM DYNASEAL 310	3000	310
6	9	568297.N			2953	-
7	9	554253.N	3/4"	PLUG PIPE THREADED MNPT STEEL SOLID SQUARE HEAD B.F. CLASS 3000		33
7	1	558551.N	4" x 4" x 4"	TEE 3-WAY WELD-END Y-52 STEEL 0.237" x 0.237" x 0.237" WT	2738	33
8	5	558555.N	6" x 6" x 4"	TEE 3-WAY WELD-END Y-52 STEEL 0.280" x 0.280" x 0.237" WT	2197	
9	1	558554.N	6" x 6" x 6"	TEE 3-WAY WELD-END Y-52 STEEL 0.280" x 0.280" x 0.280" WT	2197	3
10	1	558552.N	4" x 4" x 2"	TEE 3-WAY WELD-END Y-52 STEEL 0.237" x 0.237" x 0.154" WT	2738	3
11	1	P.O.	4" x 2-5/8"	PIPE X-52 STEEL BARE 0.237" WT	2738	12
12	1	P.O.	4" x 37"	PIPE X-52 STEEL BARE 0.237" WT	2738	12
-	2	558218.N	2" x 6"	NIPPLE PIPE THREADED ONE END MNPT SCH. 80 EX-HVY STEEL (12" LONG, CUT TO 6")	780	31
13	2	568348.N	2"	BALL VALVE THREADED FNPT BALLOMAX REGULAR PORT W/ 2" OPERATING NUT	500	-
	2	554223.N	2"	PLUG PIPE THREADED MNPT M.I. SOLID SQUARE HEAD	300	_
14	3	568351.N	4"	BALL VALVE WELD-END ANSI 150 BALLOMAX REGULAR PORT WITH 2" NUT	285	
15	3	558032.N	6"	CAP PIPE WELD-END Y-52 STEEL 0.280" WT	2197	3
16	2	568352.N	6"	BALL VALVE WELD-END ANSI 150 BALLOMAX REGULAR PORT WITH 2" NUT	285	
17	1	P.O.	6" x 18"	PIPE X-52 STEEL BARE 0.280" WT	2197	12
18	3	558071.N	6"	ELBOW PIPE 90 DEGREE WELD-END Y-52 STEEL 0.280" WT	2197	3
19	1	568235.N	6"	T-STRAINER WELD-END ANSI 300 KEROTEST TST-630 W/ 40 MESH STEEL BASKET	740	
38M N	METER CONN	NECTION ITEMS				
20	1	P.O.	6" x 22"	PIPE X-52 STEEL BARE 0.280" WT	2197	1
21	1	P.O.	6" x 9"	PIPE X-52 STEEL BARE 0.280" WT	2197	1
22	1	METER SHOP	38M175	38M LINE MOUNT METER W/IMC INSTRUMENT DEVICE	175	
	2	559222.N	6"	FLANGE RAISED FACE WELD NECK ANSI 150 FORGED STEEL	285	4
23	2	608404.N	6"	GASKET FULL FACE ANSI 150 1/16" THICK GARLOCK BLUE-GARD 3000	285	68
	16	P.O.		CAP SCREWS HEX HEAD GRADE 5 ZINC PLATED	N/A	
56M N		NECTION ITEMS	1-1.			
20	1	P.O.	6" x 22"	PIPE X-52 STEEL BARE 0.280" WT	2197	1
21	1	P.O.	6" x 6"	PIPE X-52 STEEL BARE 0.280" WT	2197	1
22	1	METER SHOP	56M175	56M LINE MOUNT METER W/IMC INSTRUMENT DEVICE	175	
-	2	559093.N	8" x 6"	FLANGE REDUCING FLAT FACE WELD NECK ANSI 150 FORGED STEEL	285	1
23	2	608405.N	8"	GASKET FULL FACE ANSI 150 1/16" THICK GARLOCK BLUE-GARD 3000	285	68
	16	P.O.	3/4" x 10 x 2-1/2"	CAP SCREWS HEX HEAD GRADE 5 ZINC PLATED	N/A	1
	10	1.0.	3/4 KIOKE I/E	ON SCHEMS HEND GIVIDE SENTER DIVES		-
24	1	558080.N	6" x 4"	ELBOW PIPE REDUCING 90 DEGREE WELD-END Y-52 STEEL 0.280" x 0.237" WT	2197	3
25	1	553715.N	3/4" x 3"	NIPPLE PIPE THREADED BOTH ENDS MNPT SCH. 40 STEEL	420	3:
26	1	P.O.	3/4 × 3	ELBOWLET STEEL B.F. CLASS 3000	2953	1
		558065.N	4"	ELBOW PIPE 90 DEGREE WELD-END Y-52 STEEL 0.237" WT	2738	1
27	2	P.O.				
28	3		4" x 6"	PIPE X-52 STEEL BARE 0.237" WT		
			4.0		2738	
	6	559214.N	4"	FLANGE RAISED FACE WELD NECK ANSI 300 FORGED STEEL	740	-
30	6	559214.N 608427.N	4"	GASKET RING ANSI 300 1/16" THICK GARLOCK BLUE-GARD 3000	740 740	6
30	6 48	559214.N 608427.N 538170.N	4" 3/4" x 4-1/2"	GASKET RING ANSI 300 1/16" THICK GARLOCK BLUE-GARD 3000 STUD BOLT WITH HEX NUTS FULL THREAD STEEL	740 740 N/A	6
_	6 48 1	559214.N 608427.N 538170.N 559222.N	4" 3/4" x 4-1/2" 6"	GASKET RING ANSI 300 1/16" THICK GARLOCK BLUE-GARD 3000 STUD BOLT WITH HEX NUTS FULL THREAD STEEL FLANGE RAISED FACE WELD NECK ANSI 150 FORGED STEEL	740 740 N/A 285	6
31 -	6 48 1 1	559214.N 608427.N 538170.N 559222.N 623033.N	4" 3/4" x 4-1/2" 6" 6"	GASKET RING ANSI 300 1/16" THICK GARLOCK BLUE-GARD 3000 STUD BOLT WITH HEX NUTS FULL THREAD STEEL FLANGE RAISED FACE WELD NECK ANSI 150 FORGED STEEL INSULATING KIT FOR ANSI 150 STEEL FLANGE SERIES 15	740 740 N/A 285 285	6 6
_	6 48 1	559214.N 608427.N 538170.N 559222.N 623033.N P.O.	4" 3/4" x 4-1/2" 6"	GASKET RING ANSI 300 1/16" THICK GARLOCK BLUE-GARD 3000 STUD BOLT WITH HEX NUTS FULL THREAD STEEL FLANGE RAISED FACE WELD NECK ANSI 150 FORGED STEEL INSULATING KIT FOR ANSI 150 STEEL FLANGE SERIES 15 PIPE X-52 STEEL BARE 0.280" WT	740 740 N/A 285 285 2197	6 6 7 1
31 - 32 33	6 48 1 1	559214.N 608427.N 538170.N 559222.N 623033.N	4" 3/4" x 4-1/2" 6" 6" 6" 4"	CASKET RING ANSI 300 1/16" THICK GARLOCK BLUE-GARD 3000 STUD BOLT WITH HEX NUTS FULL THREAD STEEL FLANGE RAISED FACE WELD NECK ANSI 150 FORGED STEEL INSULATING KIT FOR ANSI 150 STEEL FLANGE SERIES 15 PIPE X-52 STEEL BARE 0.280" WT PLUG VALVE FLANGED ANSI 300 STEEL	740 740 N/A 285 285 2197 740	6 6 7 1
31 -	6 48 1 1	559214.N 608427.N 538170.N 559222.N 623033.N P.O.	4" 3/4" x 4-1/2" 6" 6" 6" x 14-11/16"	GASKET RING ANSI 300 1/16" THICK GARLOCK BLUE-GARD 3000 STUD BOLT WITH HEX NUTS FULL THREAD STEEL FLANGE RAISED FACE WELD NECK ANSI 150 FORGED STEEL INSULATING KIT FOR ANSI 150 STEEL FLANGE SERIES 15 PIPE X-52 STEEL BARE 0.280" WT	740 740 N/A 285 285 2197	6 6 7 1
31 - 32 33	6 48 1 1 1 1	559214.N 608427.N 538170.N 559222.N 623033.N P.O. 568092.N	4" 3/4" x 4-1/2" 6" 6" 6" 4"	CASKET RING ANSI 300 1/16" THICK GARLOCK BLUE-GARD 3000 STUD BOLT WITH HEX NUTS FULL THREAD STEEL FLANGE RAISED FACE WELD NECK ANSI 150 FORGED STEEL INSULATING KIT FOR ANSI 150 STEEL FLANGE SERIES 15 PIPE X-52 STEEL BARE 0.280" WT PLUG VALVE FLANGED ANSI 300 STEEL	740 740 N/A 285 285 2197 740	6 6 7 1
31 - 32 33 34	6 48 1 1 1 1 1	559214.N 608427.N 538170.N 559222.N 623033.N P.O. 568092.N P.O.	4" 3/4" x 4-1/2" 6" 6" 6" x 14-11/16" 4" 4" x 61-11/16"	GASKET RING ANSI 300 1/16" THICK GARLOCK BLUE-GARD 3000 STUD BOLT WITH HEX NUTS FULL THREAD STEEL FLANGE RAISED FACE WELD NECK ANSI 150 FORGED STEEL INSULATING KIT FOR ANSI 150 STEEL FLANGE SERIES 15 PIPE X-52 STEEL BARE 0.280" WT PLUG VALVE FLANGED ANSI 300 STEEL PIPE X-52 STEEL BARE 0.237" WT	740 740 N/A 285 285 2197 740 2738	6 6 7 1
31 - 32 33 34 35 36	6 48 1 1 1 1 1 1 1 1	559214.N 608427.N 538170.N 559222.N 623033.N P.O. 568092.N P.O. 558222.N 568298.N	4" 3/4" × 4-1/2" 6" 6" 6" × 14-11/16" 4" × 61-11/16" 1" × 6"	GASKET RING ANSI 300 1/16" THICK GARLOCK BLUE-GARD 3000 STUD BOLT WITH HEX NUTS FULL THREAD STEEL FLANGE RAISED FACE WELD NECK ANSI 150 FORGED STEEL INSULATING KIT FOR ANSI 150 STEEL FLANGE SERIES 15 PIPE X-52 STEEL BARE 0.280" WT PIUG VALVE FLANGED ANSI 300 STEEL PIPE X-52 STEEL BARE 0.237" WT NIPPLE PIPE THREADED ONE END MNPT SCH. 80 EX-HVY STEEL METER VALVE THAREADED ONE END MNPT SCH. 80 EX-HVY STEEL METER VALVE THAREADED FNPT WKM DYNASEAL 310	740 740 N/A 285 285 2197 740 2738 510	6 6 7 1
31 - 32 33 34 35 36 37	6 48 1 1 1 1 1 1	559214.N 608427.N 538170.N 559222.N 623033.N P.O. 568092.N P.O. 558222.N 558228.N 5582770.N	4" 3/4" x 4-1/2" 6" 6" 6" x 14-11/16" 4" x 61-11/16" 1" x 6" 1"	GASKET RING ANSI 300 1/16" THICK GARLOCK BLUE-GARD 3000 STUD BOLT WITH HEX NUTS FULL THREAD STEEL FLANGE RAISED FACE WELD NECK ANSI 150 FORGED STEEL INSULATING KIT FOR ANSI 150 STEEL FLANGE SERIES 15 PIPE X-52 STEEL BARE 0.280" WT PLUG VALVE FLANGED ANSI 300 STEEL PIPE X-52 STEEL BARE 0.237" WT NIPPLE PIPE THREADED ONE END MNPT SCH. 80 EX-HVY STEEL METER VALVE THREADED FNPT WKM DYNASEAL 310 NIPPLE PIPE THREADED BOTH ENDS MNPT SCH. 40 STEEL	740 740 N/A 285 285 2197 740 2738 510 3000	6 6 7 1 1 3
31 - 32 33 34 35 36 37 38	6 48 1 1 1 1 1 1 1 1 2	559214.N 608427.N 538170.N 559222.N 623033.N P.O. 568092.N P.O. 558222.N 568298.N 553770.N 554088.N	4" 3/4" x 4-1/2" 6" 6" 6" x 14-11/16" 4" x 6-1-11/16" 1" x 6" 1" 1" x 1" x 3/4"	GASKET RING ANSI 300 1/16" THICK GARLOCK BLUE-GARD 3000 STUD BOLT WITH HEX NUTS FULL THREAD STEEL FLANGE RAISED FACE WELD NECK ANSI 150 FORGED STEEL INSULATING KIT FOR ANSI 150 STEEL FLANGE SERIES 15 PIPE X-52 STEEL BARE 0.280" WT PLUG VALVE FLANGED ANSI 300 STEEL PIPE X-52 STEEL BARE 0.237" WT INPPLE PIPE THREADED ONE END MNPT SCH. 80 EX-HVY STEEL METER VALVE THREADED FNPT WKM DYNASEAL 310 NIPPLE PIPE THREADED BOTH ENDS MNPT SCH. 40 STEEL TEE 3-WAY REDUCING THREADED FNPT M.I.	740 740 N/A 285 285 2197 740 2738 510 3000 420 300	6 6 7 1 1 3
31 - 32 33 34 35 36 37 38 39	6 48 1 1 1 1 1 1 1 2 1 1	559214.N 608427.N 538170.N 559222.N 623033.N P.O. 568092.N P.O. 558222.N 568298.N 553770.N 554088.N 554253.N	4" 3/4" x 4-1/2" 6" 6" 6" x 14-11/16" 4" x 61-11/16" 1" x 5" 1" 1" x 1" x 3/4" 3/4"	GASKET RING ANSI 300 1/16" THICK GARLOCK BLUE-GARD 3000 STUD BOLT WITH HEX NUTS FULL THREAD STEEL FLANGE RAISED FACE WELD NECK ANSI 150 FORGED STEEL INSULATING KIT FOR ANSI 150 STEEL FLANGE SERIES 15 PIPE X-52 STEEL BARE 0.280" WT PIUG VALVE FLANGED ANSI 300 STEEL PIPE X-52 STEEL BARE 0.237" WT NIPPLE PIPE THREADED ONE END MNPT SCH. 80 EX-HVY STEEL METER VALVE THAREADED FNPT WKM DYNASEAL 310 NIPPLE PIPE THREADED BOTH ENDS MNPT SCH. 40 STEEL TEE 3-WAY REDUCING THREADED FNPT M.I. PLUG PIPE THREADED THREADED FNPT M.I. PLUG PIPE THREADED MNPT STEEL SOLID SQUARE HEAD B.F. CLASS 3000	740 740 N/A 285 285 2197 740 2738 510 3000 420 300 2953	6 6 7 1 1 3
31 - 32 33 34 35 36 37 38	6 48 1 1 1 1 1 1 1 2 1 1 1 1 1 1 1 1 1 1 1	559214.N 608427.N 538170.N 559222.N 623033.N P.O. 568092.N P.O. 558222.N 558222.N 558270.N 554088.N 554253.N P.O.	4" 3/4" x 4-1/2" 6" 6" 6" x 14-11/16" 4" x 61-11/16" 1" x 6" 1" 1" x 3/4" 1/2" x 6"	GASKET RING ANSI 300 1/16" THICK GARLOCK BLUE-GARD 3000 STUD BOLT WITH HEX NUTS FULL THREAD STEEL FLANGE RAISED FACE WELD NECK ANSI 150 FORGED STEEL INSULATING KIT FOR ANSI 150 STEEL FLANGE SERIES 15 PIPE X-52 STEEL BARE 0.280" WT PLUG VALVE FLANGED ANSI 300 STEEL PIPE X-52 STEEL BARE 0.237" WT NIPPLE PIPE THREADED ONE END MNPT SCH. 80 EX-HVY STEEL METER VALVE THREADED FNPT WKM DYNASEAL 310 NIPPLE PIPE THREADED BOTH ENDS MNPT SCH. 40 STEEL TEE 3-WAY REDUCING THREADED FNPT M.I. PLUG PIPE THREADED MNPT STEEL SOLID SQUARE HEAD B.F. CLASS 3000 SQUARE PLATE (SEE GCS 209)	740 740 N/A 285 285 2197 740 2738 510 3000 420 300 2953 N/A	6 6 7 1 1 3
31 - 32 33 34 35 36 37 38 39 40 -	6 48 1 1 1 1 1 1 1 2 1 1 6 6	559214.N 608427.N 538170.N 559222.N 623033.N P.O. 568092.N P.O. 558222.N 568298.N 553770.N 554088.N 554253.N P.O.	4" 3/4" x 4-1/2" 6" 6" 6" 6" 4" 4" x 61-11/16" 1" x 6" 1" 1" x 1" 3/4" 1/2" x 6" 12" x 12" x 1/16"	CASKET RING ANSI 300 1/16" THICK GARLOCK BLUE-GARD 3000 STUD BOLT WITH HEX NUTS FULL THREAD STEEL FLANGE RAISED FACE WELD NECK ANSI 150 FORGED STEEL INSULATING KIT FOR ANSI 150 STEEL FLANGE SERIES 15 PIPE X-52 STEEL BARE 0.280" WT PLUG VALVE FLANGED ANSI 300 STEEL PIPE X-52 STEEL BARE 0.287" WT NIPPLE PIPE THREADED ONE KIND MNPT SCH. 80 EX-HVY STEEL METER VALVE THREADED FNPT WKM DYNASEAL 310 NIPPLE PIPE THREADED BOTH ENDS MNPT SCH. 40 STEEL TEE 3-WAY REDUCING THREADED FNPT M I. PLUG PIPE THREADED MNPT STEEL SOLID SQUARE HEAD B.F. CLASS 3000 SQUARE PLATE (SEE GCS 209) INSULATING SQUARE FIBER BOARDS	740 740 N/A 285 285 2197 740 2738 510 3000 420 300 2953 N/A N/A	6 6 7 1 1 3
31 - 32 33 34 35 36 37 38 39 40 -	6 48 1 1 1 1 1 1 1 2 1 1 1 6 6 6 N/A	559214.N 608427.N 538170.N 559222.N 623033.N P.O. 568092.N P.O. 558222.N 568298.N 553770.N 554088.N 554088.N 554046.N P.O.	4" 3/4" x 4-1/2" 6" 6" 6" x 14-11/16" 4" x 61-11/16" 1" x 6" 1" 1" x 3/4" 1/2" x 6"	GASKET RING ANSI 300 1/16" THICK GARLOCK BLUE-GARD 3000 STUD BOLT WITH HEX NUTS FULL THREAD STEEL FLANGE RAISED FACE WELD NECK ANSI 150 FORGED STEEL INSULATING KIT FOR ANSI 150 STEEL FLANGE SERIES 15 PIPE X-52 STEEL BARE 0.280" WT PLUG VALVE FLANGED ANSI 300 STEEL PIPE X-52 STEEL BARE 0.237" WT NIPPLE PIPE THREADED ONE END MNPT SCH. 80 EX-HVY STEEL METER VALVE THAREADED FNPT WKM DYNASEAL 310 NIPPLE PIPE THREADED BOTH ENDS MNPT SCH. 40 STEEL TEE 3-WAY REDUCING THREADED FNPT M.I. PLUG PIPE THREADED MNPT STEEL SOLID SQUARE HEAD B.F. CLASS 3000 SQUARE PLATE (SEE GCS 209) INSULATING SQUARE FIBER BOARDS —TAG ITEM NUMBER NOT USED—	740 740 740 N/A 285 285 2197 740 2738 510 3000 420 300 2953 N/A N/A	6 6 7 1 1 3
31 - 32 33 34 35 36 37 38 39 40 - 41 42	6 48 1 1 1 1 1 1 1 2 1 1 1 6 6 6 N/A	559214.N 608427.N 558170.N 559222.N 623033.N P.O. 558222.N 568298.N 553770.N 554088.N 554253.N P.O. 623046.N N/A	4" 3/4" x 4-1/2" 6" 6" 6" 14-11/16" 4" x 61-11/16" 1" x 6" 1" 1" x 1" x 3/4" 1/2" x 6" 12" x 12" x 1/16" N/A	GASKET RING ANSI 300 1/16" THICK GARLOCK BLUE-GARD 3000 STUD BOLT WITH HEX NUTS FULL THREAD STEEL FLANGE RAISED FACE WELD NECK ANSI 150 FORGED STEEL INSULATING KIT FOR ANSI 150 STEEL FLANGE SERIES 15 PIPE X-52 STEEL BARE 0.280" WT PLUG VALVE FLANGED ANSI 300 STEEL PIPE X-52 STEEL BARE 0.237" WT NIPPLE PIPE THREADED ONE END MNPT SCH. 80 EX-HVY STEEL METER VALVE THREADED FNPT WKM DYNASEAL 310 NIPPLE PIPE THREADED BOTH ENDS MNPT SCH. 40 STEEL TEE 3-WAY REDUCING THREADED FNPT M.I. PLUG PIPE THREADED MNPT STEEL SOLID SQUARE HEAD B.F. CLASS 3000 SQUARE PLATE (SEE GCS 209) INSULATING SQUARE FIBER BOARDS —-TAG ITEM NUMBER NOT USED— PLUG VALVE LOCKING DEVICE	740 740 740 N/A 285 285 2197 740 2738 510 3000 420 300 2953 N/A N/A N/A N/A	6 6 7 1 1 3
31 - 32 33 34 35 36 37 38 39 40 -	6 48 1 1 1 1 1 1 1 2 1 1 1 6 6 6 N/A 1 1 1	559214.N 608427.N 538170.N 559222.N 623033.N P.O. 568092.N P.O. 558222.N 568298.N 554253.N P.O. 623046.N N/A 568142.N 716040.N	4" 3/4" x 4-1/2" 6" 6" 6" 6" 4" 4" x 61-11/16" 1" x 6" 1" 1" x 1" 3/4" 1/2" x 6" 12" x 12" x 1/16" N/A	CASKET RING ANSI 300 1/16" THICK GARLOCK BLUE-GARD 3000 STUD BOLT WITH HEX NUTS FULL THREAD STEEL FLANGE RAISED FACE WELD NECK ANSI 150 FORGED STEEL INSULATING KIT FOR ANSI 150 STEEL FLANGE SERIES 15 PIPE X-52 STEEL BARE 0.280" WT PLUG VALVE FLANGED ANSI 300 STEEL PIPE X-52 STEEL BARE 0.280" WT NIPPLE PIPE THREADED ENDE KIND KIND KIND KIND KIND KIND KIND KIND	740 740 740 N/A 285 285 2197 740 2738 510 3000 420 300 40 N/A N/A N/A N/A	11 1 3 3 3
31 - 32 33 34 35 36 37 38 39 40 - 41 42 43	6 48 1 1 1 1 1 1 1 1 1 1 1 1 1 1 1 1 1 1	559214.N 608427.N 538170.N 559222.N 623033.N P.O. 568092.N P.O. 568298.N 553770.N 554088.N 554253.N P.O. 623046.N N/A 568142.N 716040.N 553656.N	4" 3/4" x 4-1/2" 6" 6" 6" 6" x 14-11/16" 4" 4" x 61-11/16" 1" 1" 1" 1" x 1" 3/4" 1/2" x 6" 12" x 1/16" N/A - N/A 1/2" x 3"	GASKET RING ANSI 300 1/16" THICK GARLOCK BLUE-GARD 3000 STUD BOLT WITH HEX NUTS FULL THREAD STEEL FLANGE RAISED FACE WELD NECK ANSI 150 FORGED STEEL INSULATING KIT FOR ANSI 150 STEEL FLANGE SERIES 15 PIPE X-52 STEEL BARE 0.280" WT PIUG VALVE FLANGED ANSI 300 STEEL PIPE X-52 STEEL BARE 0.287" WT NIPPLE PIPE THREADED ONE END MNPT SCH. 80 EX-HVY STEEL METER VALVE THAREADED FORT WKM DYNASEAL 310 NIPPLE PIPE THREADED BOTH ENDS MNPT SCH. 40 STEEL TEE 3-WAY REDUCING THEADED FNPT M.I. PLUG PIPE THREADED MNPT STEEL SOLID SQUARE HEAD B.F. CLASS 3000 SQUARE PLATE (SEE GCS 209) INSULATING SQUARE FIBER BOARDS -TLAG ITEM NUMBER NOT USED PLUG VALVE LOCKING DEVICE PADLOCK MASTER BRASS BODY AND KEYS NIPPLE PIPE THREADED BOTH ENDS MNPT SCH. 40 STEEL	740 740 740 N/A 285 285 285 740 2738 510 3000 420 300 2953 N/A N/A N/A N/A 420	66 66 77 11 13 3
31 - 32 33 34 35 36 37 38 39 40 - 41 42	6 48 1 1 1 1 1 1 1 2 1 1 1 6 6 6 N/A 1 1 1	559214.N 608427.N 538170.N 559222.N 623033.N P.O. 568092.N P.O. 558222.N 568298.N 554253.N P.O. 623046.N N/A 568142.N 716040.N	4" 3/4" x 4-1/2" 6" 6" 6" 6" 4" 4" x 61-11/16" 1" x 6" 1" 1" x 1" 3/4" 1/2" x 6" 12" x 12" x 1/16" N/A	CASKET RING ANSI 300 1/16" THICK GARLOCK BLUE-GARD 3000 STUD BOLT WITH HEX NUTS FULL THREAD STEEL FLANGE RAISED FACE WELD NECK ANSI 150 FORGED STEEL INSULATING KIT FOR ANSI 150 STEEL FLANGE SERIES 15 PIPE X-52 STEEL BARE 0.280" WT PLUG VALVE FLANGED ANSI 300 STEEL PIPE X-52 STEEL BARE 0.280" WT NIPPLE PIPE THREADED ENDE KIND KIND KIND KIND KIND KIND KIND KIND	740 740 740 N/A 285 285 2197 740 2738 510 3000 420 300 40 N/A N/A N/A N/A	66 66 77 11 13 3
31 - 32 33 34 35 36 37 38 39 40 - 41 42 43	6 48 1 1 1 1 1 1 1 1 1 1 1 1 1 1 1 1 1 1	559214.N 608427.N 538170.N 559222.N 623033.N P.O. 568092.N P.O. 568298.N 553770.N 554088.N 554253.N P.O. 623046.N N/A 568142.N 716040.N 553656.N	4" 3/4" x 4-1/2" 6" 6" 6" 6" x 14-11/16" 4" 4" x 61-11/16" 1" 1" 1" 1" x 1" 3/4" 1/2" x 6" 12" x 1/16" N/A - N/A 1/2" x 3"	GASKET RING ANSI 300 1/16" THICK GARLOCK BLUE-GARD 3000 STUD BOLT WITH HEX NUTS FULL THREAD STEEL FLANGE RAISED FACE WELD NECK ANSI 150 FORGED STEEL INSULATING KIT FOR ANSI 150 STEEL FLANGE SERIES 15 PIPE X-52 STEEL BARE 0.280" WT PIUG VALVE FLANGED ANSI 300 STEEL PIPE X-52 STEEL BARE 0.287" WT NIPPLE PIPE THREADED ONE END MNPT SCH. 80 EX-HVY STEEL METER VALVE THAREADED FORT WKM DYNASEAL 310 NIPPLE PIPE THREADED BOTH ENDS MNPT SCH. 40 STEEL TEE 3-WAY REDUCING THEADED FNPT M.I. PLUG PIPE THREADED MNPT STEEL SOLID SQUARE HEAD B.F. CLASS 3000 SQUARE PLATE (SEE GCS 209) INSULATING SQUARE FIBER BOARDS -TLAG ITEM NUMBER NOT USED PLUG VALVE LOCKING DEVICE PADLOCK MASTER BRASS BODY AND KEYS NIPPLE PIPE THREADED BOTH ENDS MNPT SCH. 40 STEEL	740 740 740 N/A 285 285 285 740 2738 510 3000 420 300 2953 N/A N/A N/A N/A 420	11 1 3 3 3
31 - 32 33 34 35 36 37 38 39 40 - 41 42 43	6 48 1 1 1 1 1 1 1 2 1 1 1 6 6 6 N/A 1 1 1	559214.N 608427.N 558170.N 559222.N 623033.N P.O. 558222.N 568298.N 554088.N 554088.N P.O. 623046.N P.O. 623046.N 716040.N 716040.N 553656.N 5568142.N	4" 3/4" x 4-1/2" 6" 6" 6" 6" x 14-11/16" 4" 4" x 61-11/16" 1" x 6" 1" 1" 1" x 1" x 3/4" 1/2" x 6" 1/2" x 12" x 1/16" N/A 1/2" x 3" 1/2" x 3"	GASKET RING ANSI 300 1/16" THICK GARLOCK BLUE-GARD 3000 STUD BOLT WITH HEX NUTS FULL THREAD STEEL FLANGE RAISED FACE WELD NECK ANSI 515 EEL INSULATING KIT FOR ANSI 150 STEEL FLANGE SERIES 15 PIPE X-52 STEEL BARE 0.280" WT PLUG VALVE FLANGED ANSI 300 STEEL PIPE X-52 STEEL BARE 0.237" WT NIPPLE PIPE THREADED ONE END MNPT SCH. 80 EX-HVY STEEL METER VALVE THERADED FNPT WKM DYNASEAL 310 NIPPLE PIPE THREADED BOTH ENDS MNPT SCH. 40 STEEL TEE 3-WAY REDUCING THREADED FNPT M.I. PLUG PIPE THREADED MNPT STEEL SOLID SQUARE HEAD B.F. CLASS 3000 SQUARE PLATE (SEE GCS 209) INSULATING SQUARE FIBER BOARDS T-AG ITEM NUMBER NOT USED	740 740 740 N/A 285 285 285 2197 740 3000 420 300 420 300 N/A N/A N/A N/A N/A 0/A 2000	66 66 77 11 13 3
31 - 32 33 34 35 36 37 38 39 40 - 41 42 43 48	6 48 1 1 1 1 1 1 1 2 1 1 1 6 6 6 N/A 1 1 1	559214.N 608427.N 558170.N 559222.N 623033.N P.O. 558222.N 568298.N 554088.N 554088.N P.O. 623046.N P.O. 623046.N 716040.N 716040.N 553656.N 5568142.N	4" 3/4" x 4-1/2" 6" 6" 6" 6" x 14-11/16" 4" 4" x 61-11/16" 1" x 6" 1" 1" 1" x 1" x 3/4" 1/2" x 6" 1/2" x 12" x 1/16" N/A 1/2" x 3" 1/2" x 3"	GASKET RING ANSI 300 1/16" THICK GARLOCK BLUE-GARD 3000 STUD BOLT WITH HEX NUTS FULL THREAD STEEL FLANGE RAISED FACE WELD NECK ANSI 150 FORGED STEEL INSULATING KIT FOR ANSI 150 STEEL FLANGE SERIES 15 PIPE X-52 STEEL BARE 0.280" WT PIUG VALVE FLANGED ANSI 300 STEEL PIPE X-52 STEEL BARE 0.287" WT NIPPLE PIPE THREADED ONE END MNPT SCH. 80 EX-HVY STEEL METER VALVE THAREADED FNPT WKM DYNASEAL 310 NIPPLE PIPE THREADED BOTH ENDS MNPT SCH. 40 STEEL TEE 3-WAY REDUCING THEADED FNPT MI. PLUG PIPE THREADED MNPT STEEL SOLID SQUARE HEAD B.F. CLASS 3000 SQUARE PLATE (SEE GCS 209) INSULATING SQUARE FIBER BOARDS -TAG ITEM NUMBER NOT USED PLUG VALVE LOCKING DEVICE PADLOCK MASTER BRASS BODY AND KEYS NIPPLE PIPE THREADED BOTH ENDS MNPT SCH. 40 STEEL BALL VALVE FULL PORT THREADED FNPT CARBON STEEL BALL VALVE FULL PORT THREADED FNPT CARBON STEEL PLUG PIPE THREADED BOTH ENDS MNPT SCH. 40 STEEL BALL VALVE FULL PORT THREADED FNPT CARBON STEEL PLUG PIPE THREADED MNPT STEEL SOLID SQUARE HEAD B.F. CLASS 3000 INTERCHANOEABLE ITEMS	740 740 740 N/A 285 285 285 2197 740 3000 420 300 420 300 N/A N/A N/A N/A N/A 0/A 2000	66 66 77 11 13 3
31 - 32 33 34 35 36 37 38 39 40 - 41 42 43 48	6 48 1 1 1 1 1 1 1 1 1 1 1 1 1 1 1 1 1 1	559214.N 608427.N 558170.N 559222.N 623033.N P.O. 558222.N 568298.N 554253.N P.O. 623046.N N/A 716040.N 553656.N 554215.N	4" 3/4" x 4-1/2" 6" 6" 6" 6" 4" 4" x 61-11/16" 1" x 6" 1" 1" 1" x 1" x 3/4" 1/2" x 6" 12" x 12" x 1/16" N/A 1/2" x 3" 1/2" 1/2" 1/2" 1/2"	CASKET RING ANSI 300 1/16" THICK GARLOCK BLUE-GARD 3000 STUD BOLT WITH HEX NUTS FULL THREAD STEEL FLANGE RAISED FACE WELD NECK ANSI 150 FORGED STEEL INSULATING KIT FOR ANSI 150 STEEL FLANGE SERIES 15 PIPE X-52 STEEL BARE 0.280" WT PLUG VALVE FLANGED ANSI 300 STEEL PIPE X-52 STEEL BARE 0.280" WT PLUG VALVE FLANGED ANSI 300 STEEL PIPE X-52 STEEL BARE 0.287" WITH STEEL FLANGE SERIES 15 PIPE X-52 STEEL BARE 0.280" WT PLUG VALVE FLANGED ANSI 300 STEEL PIPE X-52 STEEL BARE 0.287" WITH STEEL SOULD SEX-HVY STEEL METER VALVE THREADED FOR THE MEM DOWNASEAL 310 NIPPLE PIPE THREADED BOTH ENDS MNPT SCH. 40 STEEL TEE 3-WAY REDUCING THREADED FNPT M.I. PLUG PIPE THREADED MNPT STEEL SOULD SQUARE HEAD B.F. CLASS 3000 SQUARE PLATE (SEE GCS 209) INSULATING SQUARE FIBER BOARDS -TAG ITEM NUMBER NOT USED- PLUG VALVE LOCKING DEVICE PADLOCK MASTER BRASS BODY AND KEYS NIPPLE PIPE THREADED BOTH ENDS MNPT SCH. 40 STEEL BALL VALVE FULL PORT THREADED FNPT CARBON STEEL PLUG PIPE THREADED MNPT STEEL SOLID SQUARE HEAD B.F. CLASS 3000 INTERCHANGEABLE ITEMS REGULATOR MOONEY FLANGED ANSI 300 STEEL (4IN W/SERIES 20 PILOT=628245)	740 740 740 N/A 285 285 2197 740 2738 510 3000 420 300 420 300 470 N/A N/A N/A N/A 2000 2953	66 66 70 11 1 1 1 3 3 3 3 3 3 3 3 3 3 3 3 3 3 3
31 - 32 33 34 35 36 37 38 39 40 - 41 42 43 48	6 48 1 1 1 1 1 1 1 1 2 1 1 6 6 N/A 1 1 1 1 1 1 1 1 1 1 1 1 1 1 1 1 1 1 1	559214.N 608427.N 538170.N 559222.N 623033.N P.O. 558222.N 568298.N 553770.N 554088.N P.O. 623046.N N/A 568142.N 716040.N 553656.N 558211.N	4" 3/4" x 4-1/2" 6" 6" 6" 6" x 14-11/16" 4" 4" x 61-11/16" 1" 1" 1" 1" x 1" x 3/4" 1/2" x 6" 12" x 12" x 1/16" N/A 1/2" x 3" 1/2" 1/2" 1/2"	GASKET RING ANSI 300 1/16" THICK GARLOCK BLUE-GARD 3000 STUD BOLT WITH HEX NUTS FULL THREAD STEEL FLANGE RAISED FACE WELD NECK ANSI 150 FORGED STEEL INSULATING KIT FOR ANSI 150 STEEL FLANGE SERIES 15 PIPE X-52 STEEL BARE 0.280" WT PIUG VALVE FLANGED ANSI 300 STEEL PIPE X-52 STEEL BARE 0.287" WT NIPPLE PIPE THREADED ONE END MNPT SCH. 80 EX-HVY STEEL METER VALVE THAREADED FNPT WKM DYNASEAL 310 NIPPLE PIPE THREADED BOTH ENDS MNPT SCH. 40 STEEL TEE 3-WAY REDUCING THEADED FNPT MI. PLUG PIPE THREADED MNPT STEEL SOLID SQUARE HEAD B.F. CLASS 3000 SQUARE PLATE (SEE GCS 209) INSULATING SQUARE FIBER BOARDS -TAG ITEM NUMBER NOT USED PLUG VALVE LOCKING DEVICE PADLOCK MASTER BRASS BODY AND KEYS NIPPLE PIPE THREADED BOTH ENDS MNPT SCH. 40 STEEL BALL VALVE FULL PORT THREADED FNPT CARBON STEEL BALL VALVE FULL PORT THREADED FNPT CARBON STEEL PLUG PIPE THREADED BOTH ENDS MNPT SCH. 40 STEEL BALL VALVE FULL PORT THREADED FNPT CARBON STEEL PLUG PIPE THREADED MNPT STEEL SOLID SQUARE HEAD B.F. CLASS 3000 INTERCHANOEABLE ITEMS	740 740 740 N/A 285 285 285 2197 740 3000 2953 N/A N/A N/A N/A N/A 2000 2953	11 44 68 66 6 44 76 11 11 11 11 11 11 11 11 11 11 11 11 11

PAINT CURB VALVE BOX RED

METERSET NOTES:

TOP VIEW

DESIGN CRITERIA (MAX DAY)

14 PSIG

25 PSIG

25 PSIG


2 PSIG

69.332 MCFH

- PROPOSED PIPE AND FITTINGS TO BE DESIGNED, TESTED, AND RATED FOR 230 PSIG PER NICOR GAS ENGINEERING DEPARTMENT.
- SYSTEM OPERATIONS TO VERIFY REGULATOR & RELIEF SET POINTS PRIOR TO METER SET INSTALLATION.
- REFERENCE GCS 957.1 & 957.2 FOR METER SET DAMAGE PREVENTION & PROTECTION.
- DOWNSTREAM DELIVERY PRESSURE NOT TO EXCEED THE LOWEST RATED ITEM ON THE METERSET.
- REFERENCE GCS 502 FOR PAINT SPECIFICATIONS.

	METERSET DRAWING						APPROVED FOR					COUNTY TOWNS DUPAGE DOWN TOWN TIER HINSDALE T38N	ERS GROVE RANGE R11E 3PM	1/4 SECTION 131
	VERSION					CONSTRUCTION					REGION DEPARTMENT CENTRAL CONSTRUCTION WORK ORDER NO	ENGINEER/DESIGNER C. NGUYEN DRAWN BY	DATE 05/06/2020 DATE	
												150688/350688	ENGINEERING	07/01/2016
			-	-	-			-	-	-	-	NICOR JOB NO. NODE/LD NO. NBA1846049	CHECKED BY T. CABEZAS	DATE 06/01/2016
													CORROSION	DATE
2	Y-52	JN	MJ	GMS	3/15/18			-		-		SCALE 1" = 1'-3"	APPROVED BY G. STIGLIC	DATE 07/01/2016
VER.	DESCRIPTION			BY APP'D. B		REV.	DESCRIPTION	BY	CHK'D B	Y APP'D. B	Y DATE	DATE IN SERVICE	DRAWING FILE NO. WC21131A -	SHEET 4 OF 5

A Nicor Gas

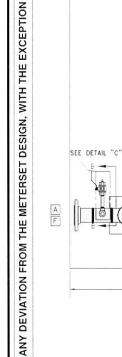


RISER PRESSURE MIN.


DELIVERY PRESSURE

SYSTEM M.O.P.

SYSTEM OPER. PRESSURE

C

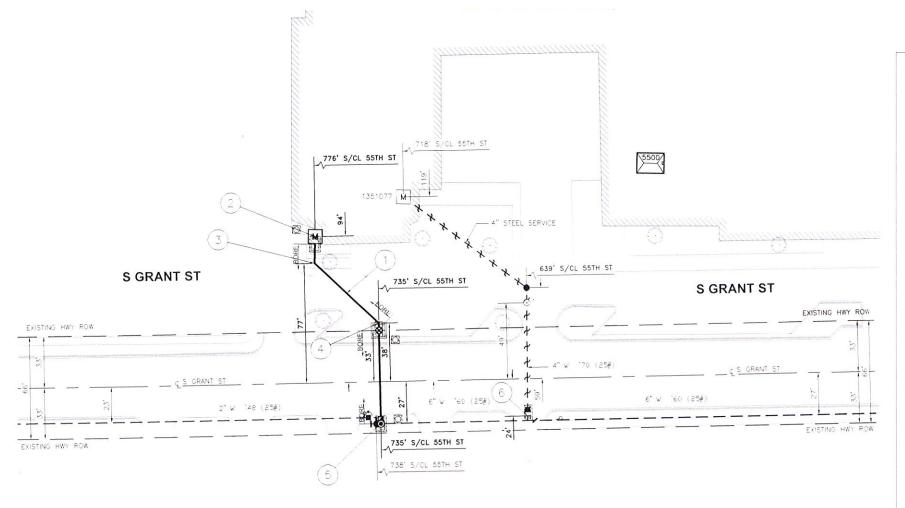

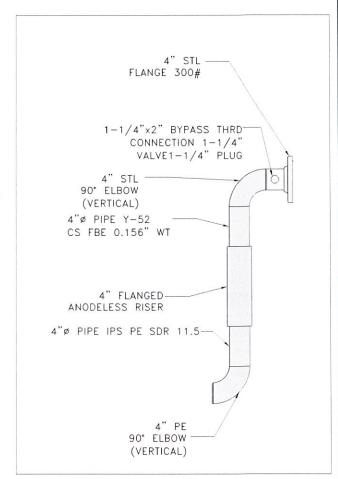

- INSTALL (138') 4"¢ PIPE IPS PE SDR 11.5 (TEST SECTION 'A')
- INSTALL

 (1) 38M METERSET
 SEE PAGE 4 FOR DETAIL

 (1) 4" 90' ELL IPS PE SDR 11.5 (VERTICAL)

 (1) 4" ANODELESS RISER W/ANSI 300 FLANGE (SEE GMS 940.8 FOR COMPLETE LIST OF MATERIAL)

 (1) GCS 262.4* (FLANGED ASSEMBLY)

 *INCL: (1) 4" GASKET ANSI 300# FLG 1/16" THK

 (1) BOLT STUD STL 3/4"ø x 4-1/2" LG B7

 W/ (2) 2H HEX NUTS FULL THRD 2
- INSTALL
 (1) 4" 45" ELL IPS PE SDR 11.5
- INSTALL

 (1) 4" 45' ELL IPS PE SDR 11.5

 (1) GCS 725.04* (4" PE VALVE INSTALLATION BF)

 *INCL: (1) 4" POLY VALVE IPS PE BF W/PUP 15 LONG

 (1) 6" EXTENSION VALVE BOX

 (1) BLOCK WOOD 2"X10"X12"

 (1) COPPER WIRE #12 GAUGE HARD DRAWN HMWPE

 2500' SPOOLS YELLOW TRACING WIRE, 12 AWG SOLID

 (AS REQUIRED) (4)

BREAK & TEMP REPLACE
(1) 5'x10' ASPHALT PAVEMENT

- INSTALL

 (1) GCS 210.38* (6" PCF TAP INTO PIPE STL HDR/LAT)

 *INCL: (1) 6"x6"x4" TEE RED CS W 0.280"X0.280"X0.237" WT Y-52

 (1) 6" CAP CS W 0.280" WT Y-52

 (1) 4"x4" FITTING TRANS STL PE SDR 11.5 W/GCS 702

 (ANTI SHEAR SLEEVE PE PIPE)

 (1) GCS 714.33 (ETC WIRE CONNECTION [W/ DETACHABLE ANODE WIRE] FOR STL

 TO PE SYSTEMS)

 *INCL: (1) BOX TERMINAL 18" LG 4" OD

 (1) 32# ANODE INSTALLED ON EXISTING PIPE SEE SPEC FOR

 COMPLETE LIST OF REQUIRED MATERIALS
- CUT & CAP
 (1) 4" CAP W CS 0.237" WT Y-52
 (SEAL RETIRED MAIN PER GCS 849)
 (CONDUCT WIPE TEST PER GCS 849.2)

BREAK & TEMP REPLACE
(1) 5'x10' ASPHALT PAVEMENT



- CONSTRUCTION NOTE:

 1. LOCATION OF EXISTING UTILITIES ARE APPROXIMATE.


 2. LOCATIONS OF BORE PITS AND STOCKPILES ARE
- 2. LOCATIONS OF BORE PITS AND STOCKPILES ARE APPROXIMATE.
 3. FIELD CONFIRM ALL SERVICE TRANSFERS PRIOR TO RETHRING ANY EXISTING MAIN.
 4. GAS MAIN LOCATION TO BE VERIFIED IN THE FIELD.



	APPRO	VED E	ΛD		COUNTY TOWNSHI DUPAGE DOWN		HIP NERS GROVE	1/4 SECTION 131		
					TOWN HINSDALE	TIER T381				
	CONST	RUCTI	ON		REGION DEPARTMENT CENTRAL CONSTRUC		ENGINEER/DESIGNER N.C. NGUYEN	DATE 05/06/2020		
				T		WORK ORDER NO. 150689/35068	89	DRAWN BY C. NGUYEN	DATE 05/26/2020	
-		-		+		NICOR JOB NO. NBA1846049	NODE/LD NO.	CHECKED BY J. GRECO	DATE 06/01/2020	
								CORROSION D. SMITH	DATE 06/02/2020	
+				+		SCALE 1:30		APPROVED BY	DATE 1/13/2021	
EV.	DESCRIPTION	BY CHK'D B	APP'D.	BY	DATE	DATE IN SERVICE		DRAWING FILE NO. 1	SHEET 3 OF 5	

WORK ORDER QUANTITIES THIS SHEET									
PIPE RETIREMENT THIS SHEET	ESTIMATED	ACTUAL							
4" PE IPS SDR 11.5	138'								
PIPE RETIREMENT THIS SHEET	ESTIMATED	ACTUAL							
4" STEEL SERVICE	96'								
4" STEEL (1970)	77'								
TRENCH BACKFILL THIS SHEET	12 CY								
TOTAL ASPHALT & CONCRETE BREAKS	100 SF								
SERVICE TRANSFERS THIS SHEET	1								

I.D.O.T. TRAFFIC MAINTENANCE STANDARDS

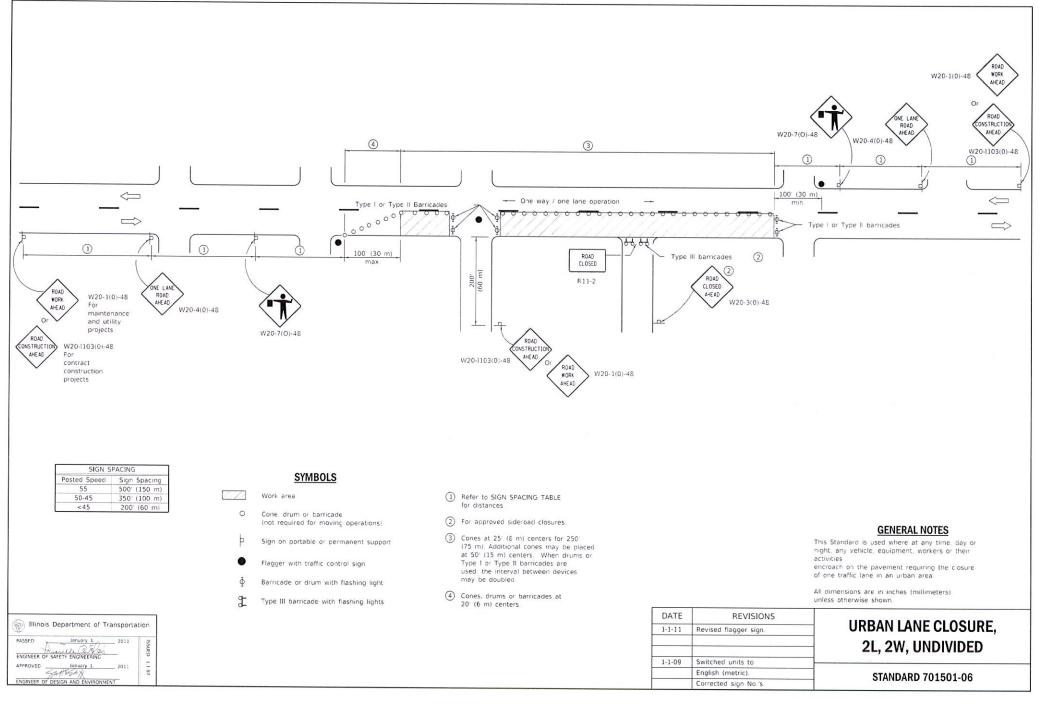

		¥		PREPARED BY:	A Ni	cor Ga	
		VED FOR	COUNTY DUPAGE TOWN HINSDALE	TOWNSHIP DOWNERS GROVE 1 TIER RANGE T38N R11E 3PM		1/4 SECTION 131	
	CONST	RUCTION		REGION CENTRAL WORK ORDER NO. 150689/3506	CONSTRUCTION	ENGINEER/DESIGNER C. NGUYEN DRAWN BY C. NGUYEN	05/06/2020 05/26/2020 05/26/2020
				NICOR JOB NO NBA1846049	NODE/LD NO.	J. GRECO	DATE 06/01/2020
				SCALE N.T.S.		CORROSION D. SMITH APPROVED BY	DATE 06/02/2020 DATE 1/13/2021
REV.	DESCRIPTION	BY CHK'D BY APP'D.	BY DATE	DATE IN SERVICE		/ /	1 13/2021 SHEET 5 OF 5