

Village of Hinsdale 19 E. Chicago Avenue Hinsdale, IL 60521-3489 (630)789-7000 Village Website: www.villageofhinsdale.org

PUBLIC SERVICES UTILITY PERMIT APPLICATION - Permit Fee of \$100.00

Date of Application:	6/16/21 Permit No/477-002	Permit Expiration Date: 10-31-21						
Utility Company In	nformation:	Contractor Information:						
Company Name: A	T&T	Company Name: JOSCO						
Address: 255 E CHIC		Address: 2551 W Division St., Suite 102						
City, State, Zip: ELG		City, State, Zip: Joliet, IL 60435						
Contact Person: MA		Contact Person: Joseph Wirtz						
Phone Number: 84		Phone Number: 815-725-1975						
Email Address: MC7		Email Address: joe.w@joscocs.com						
Cell Number: 847-86		Cell Number: 815-348-0503						
Project/Work Order								
PROJECT LOCATI	ION: CHICAGO AVE FROM BODIN ST TO LINCOLI	N ST						
ADJUST APPROXIMATELY	COVERED UNDER THIS PERMIT: IDOT CONTRACT 5 MANHOLE FRAMES & COVERS IN SIDEWALK/DRIVEWAY T OLE FRAMES & COVERS IN PAVEMENT	T # 61G38 CHICAGO AVE FROM BODIN ST TO LINCOLN ST						
Site Plan/Details/Sp Currently registered	MID JULY - COORINATE W/ROAD CNTRCTR pecifications (3 sets) included with applicati I as a Utility Contractor with the Village of H of Cost included with application?							
Type of Utility:	ComEd Nicor Communications: Fiber Optic	Comcast Water Sewer						
Applicant Informat	tion:							
Print Name: MANES	SA MONSON	Phone Number:						
Company: AT&T		Email Address: MC7962@ATT.COM						
Signature: Manessa I	Monson Digitally signed by Manessa Monson Date: 2021.06.16 10:20.51 -05'00'	Date: 6/16/21						
THE FOLLOWING: ST RECURRING SPECIAL CONTROL DEVICES FO	ANDARD SPECIFICATIONS FOR ROAD AND B . PROVISIONS BY THE ILLINOIS DEPARTMENT OR STREETS AND HIGHWAYS, STANDARD SPEC	TEST EDITION IN EFFECT ON THE DATE OF PERMIT APPLICATION OF BRIDGE CONSTRUCTION & SUPPLEMENTAL SPECIFICATIONS AND OF TRANSPORTATION, ILLINOIS MANUAL ON UNIFORM TRAFFIC IFICATIONS FOR WATER AND SEWER MAIN CONSTRUCTION IN 6 (Ord. O2007-73, 11-6-2007) AND ENGINEERING STANDARDS.						
	Village U	lse Only						
Permit Approved:	YES NO							
Conditions for Appr	oval/Reasons for Denial: Con Din A	TE ALL WORK WITH ROADWAY						

ADiaz

Approved By: MANESSA MONSON

Date: _____6/16/21

6/17

21

FOR INDEX OF SHEETS, SEE SHEET NO. 2 FOR LIST OF HIGHWAY STANDARDS, SEE SHEET NO. 2

TRAFFIC DATA

CHICAGO AVENUE ADT = 5,600 (2016) THIRD STREET = < 500

ROADWAY	POSTED SPEED	DESIGN SPEED
CHICAGO AVE	25 MPH	25 MPH
THIRD STREET	20 MPH	20 MPH


DESIGN DESIGNATION

FAU 1487 (CHICAGO AVENUE) - MAJOR COLLECTOR MUN 4030 (THIRD STREET) - LOCAL ROAD

A023ZT4 PRINT 1A



FAU ROUTE 1487 (CHICAGO AVENUE) - FROM EAST OF IL ROUTE 83 (KINGERY HWY) TO WEST OF GARFIELD STREET, THIRD STREET - FROM EAST OF GRANT STREET **TO WEST OF WASHINGTON STREET RESURFACING AND ADA SIDEWALK RAMP IMPROVEMENTS** SECTION: 19-00098-00-RS PROJECT: H6BQ(234) **VILLAGE OF HINSDALE** OMISSION WASHINGTON ST STA. 146+08.58 TO STA. 147+00.99 **DUPAGE COUNTY** C-91-076-20 PROJECT LOCATION MAP DUPAGE COUNTY, ILLINOIS N.T.S. PROJECT BEGINS STA 100+26.50 RANGE 11 EAST 5.N. 022-0211-*CHICAGO AVE OMISSION AREAS: MONROE ST MADISON ST WASHINGTON ST ***THIRD ST OMISSION AREAS:** LINCOLN ST BNSF RAILROAD **PROJECT ENDS** STA 151+67.43 W Sh S OMISSION MONROE ST STA. 118+77.25 TO STA. 119+52.70 Park OMISSION MADISON ST STA. 125+38.02 TO STA. 126+19.86 PROJECT ENDS STA 308+13.37 3RD PM **DOWNERS GROVE TOWNSHIP** OMISSION LINCOLN ST **PROJECT LENGTH** STA. 303+75.11 TO 304+52.62 GROSS LENGTH = 6,111.01 FT = 1.16 MILES NET LENGTH = 5,741.01 FT = 1.09 MILES THOMAS S. CREECH. **PROJECT BEGINS** 3-25-21 ND. 062-047669 STA 300+35.57 EXPIRES: 11/30/21 SEAL HR GREEN, INC.

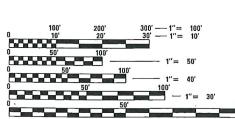

FULL SIZE PLANS HAVE BEEN PREPARED USING STANDARD ENGINEERING SCALES. REDUCED SIZED PLANS WILL NOT

ON REDUCED PLANS, THE ABOVE SCALES MAY BE USED.


J.U.L.I.E. JOINT UTILITY LOCATION INFORMATION FOR EXCAVATORS 1–800–892–0123 OR 811


CONTRACT NO. 61G38

PLO PLO

E. RAMOS, P.E. SCHAUMBURG, IL



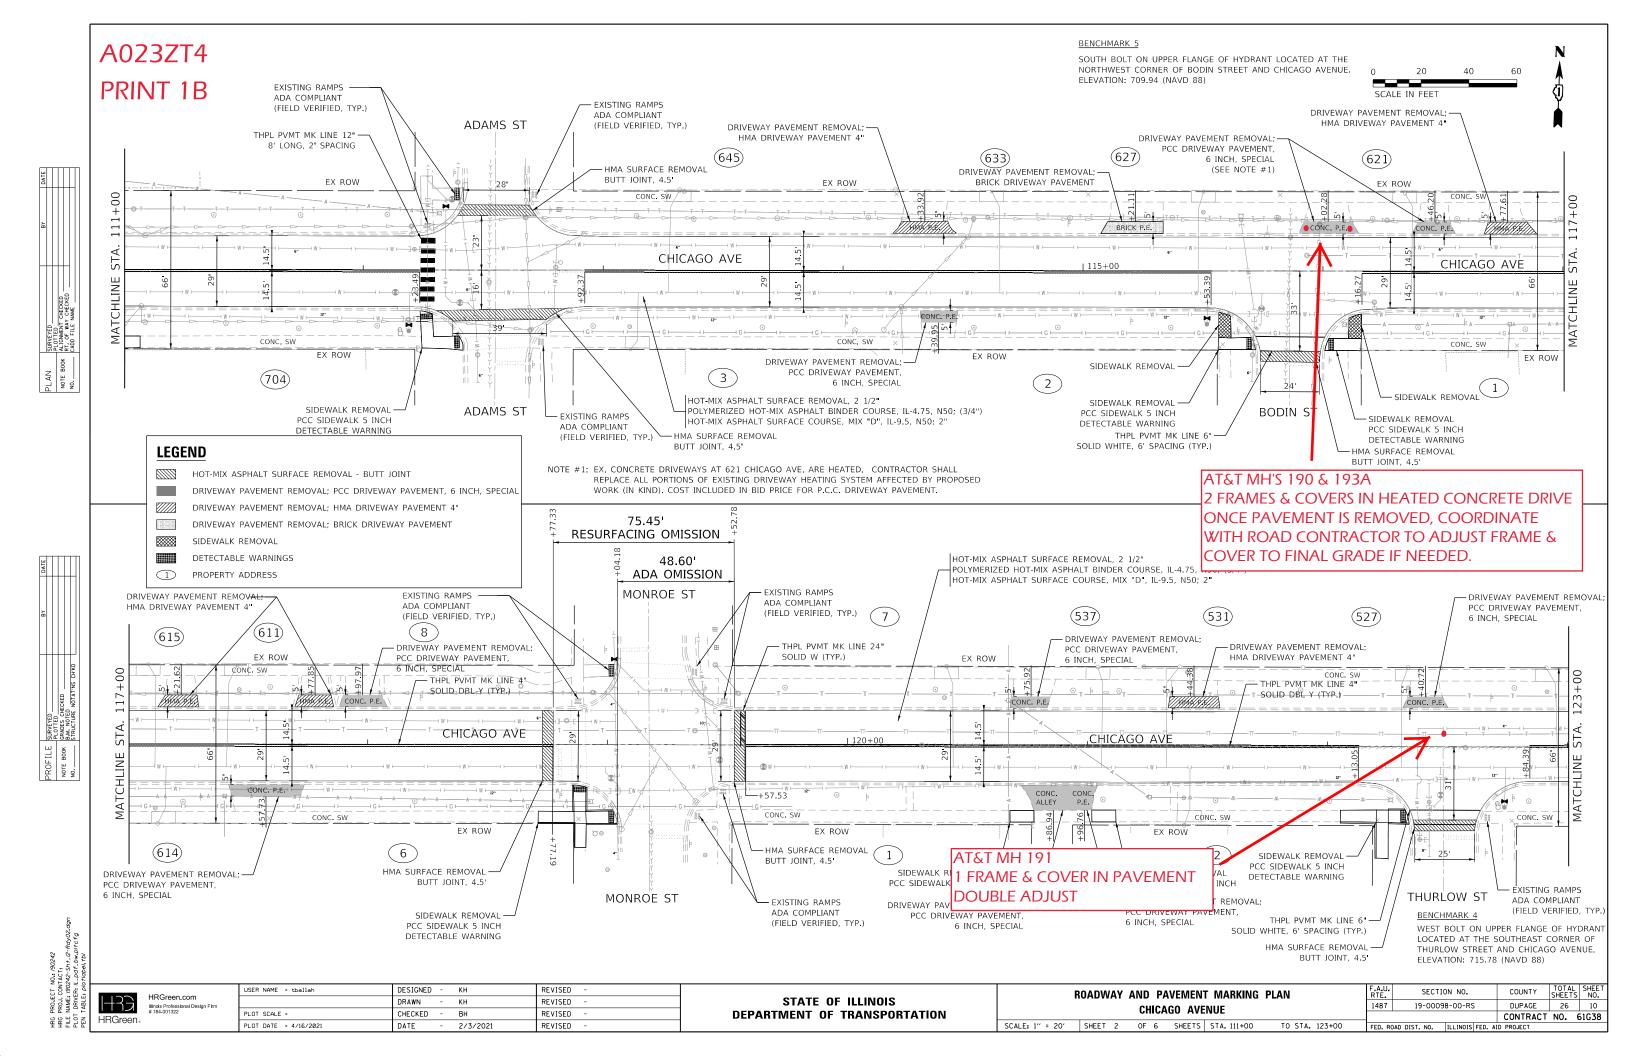

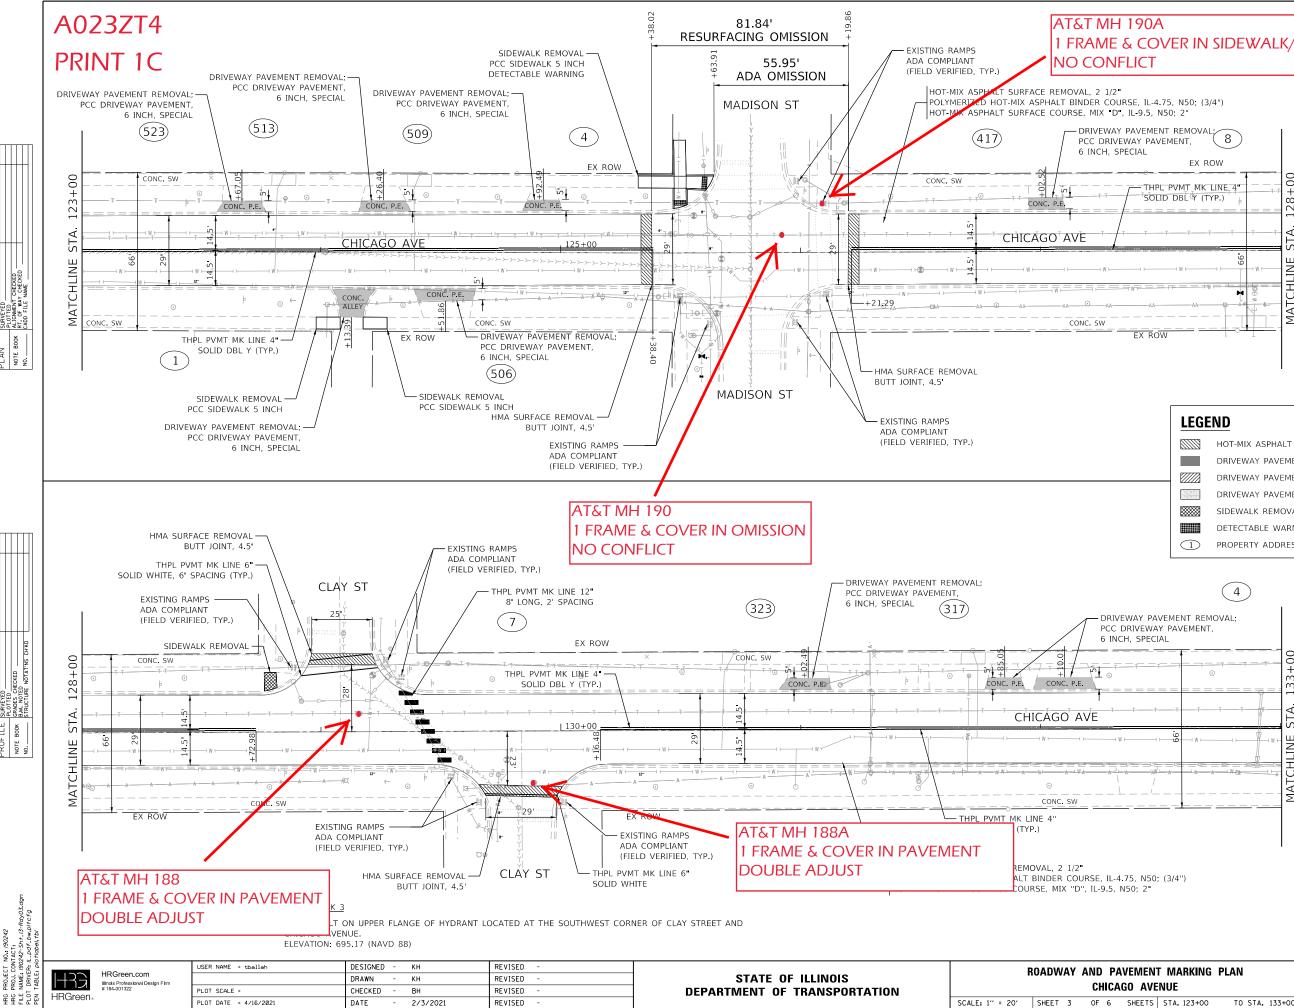


1 FRAME & COVER IN SIDEWALK/ADA - ADA COMPLIANT

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HOT-MIX ASPHALT SURFACE REMOVAL - BUTT JOINT DRIVEWAY PAVEMENT REMOVAL; PCC DRIVEWAY PAVEMENT, 6 INCH, SPECIAL DRIVEWAY PAVEMENT REMOVAL; HMA DRIVEWAY PAVEMENT 4" DRIVEWAY PAVEMENT REMOVAL; BRICK DRIVEWAY PAVEMENT SIDEWALK REMOVAL DETECTABLE WARNINGS PROPERTY ADDRESS

NT MARKING PLAN				SECTION NO.				COUNTY	TOTAL SHEETS	SHEET NO.
VE	NUE		1487	19-0009	8-00-RS			DUPAGE	26	11
	NOL							CONTRACT	NO. 0	61638
S	STA. 123+00	TO STA. 133+00	FED. RC	AD DIST. NO.	ILLINOIS	FED.	AID	PROJECT		




A023ZT4						
PRINT 1E						
					CONSTRUCTION	PROCEDURES
					STAGE 1 (BEFORE PAVEMENT MILLING	
					A) REMOVE A MINIMUM OF 12 (3 AROUND THE STRUCTURE. B) REMOVE THE EXISTING FRAM	300) OF THE PAVEMENT FROM E AND LID FROM THE STRUCTURE.
					C) COVER THE STRUCTURE OPEN METAL PLATE.	NING WITH A 36 (900) DIAMETER
					D) BACKFILL WITH CRUSHED ST THICK HMA SURFACE MIX AF	
					<u>STAGE 2</u> (AFTER PAVEMENT MILLING A) REMOVE THE HMA SURFACE	
				12 (300) MIN. (8) (9)	B) INSTALL THE FRAME AND LI FINAL SURFACE ELEVATION.	D; ADJUST THE FRAME TO ITS
					C) THE SURROUNDING SPACE SH CONCRETE TO THE ELEVATI	HALL BE FILLED WITH CLASS PP-1* ON OF THE SURFACE OF THE EXISTING
					BASE COURSE OR THE BIND * UNLESS OTHERWISE SPECIFIE	
					THE PROCEDURE EXPLAINED AB THE APPLICABLE PORTIONS OF	
					602, AND 603 OF THE STANDA EXCEPT THAT "THE CONTRACTO	RD SPECIFICATIONS DR SHALL ADJUST THE
					STRUCTURES TO THE FINISHED MORE THAN 5 CALENDAR DAYS THE FINAL LIFT OF SURFACE U	PRIOR TO PLACEMENT OF
				PROPOSED 7	ENGINEER."	
				BRICK, MORTAR, OR CONC.	LEGEND	-
					1 SUB-BASE GRANULAR MATERIAL	6 FRAME AND LID (SEE NOTES)
					2 EXISTING PAVEMENT	(7) CLASS PP-1* CONCRETE
				NOTES: EXISTING BROKEN FRAMES AND LIDS SHALL BE REMOVED	3 36 (900) DIAMETER METAL PLATE	8 PROPOSED HMA SURFACE COURS
				AND DISPOSED OF BY THE CONTRACTOR AND SHALL BE REPLACED AS DIRECTED BY THE ENGINEER. REPLACEMENT FRAMES AND LIDS WILL BE PAID FOR IN ACCORDANCE WITH ARTICLE 109.04 OF THE STANDARD SPECIFICATIONS	 PROPOSED CRUSHED STONE AND HMA SURFACE MIX EXISTING STRUCTURE 	9 proposed hma binder course
				UNLESS A SEPARATE PAY ITEM HAS BEEN PROVIDED. IF THE EXISTING LIDS ARE OPEN, THE FRAME WILL BE	LOCATION OF STRUCTURES:	
				ADJUSTED TO THE ELEVATION OF THE MILLED PAVEMENT SURFACE PRIOR TO THE MILLING OPERATION. THE FRAME WILL NOT BE REMOVED AND COVERED BY THE METAL PLATE.		ED TO KEEP A RECORD OF THE LOCATIONS ON TO THE STATION AND DISTANCE LEFT OF
				CITY OF CHICAGO CASTINGS ARE THE PROPERTY OF THE CITY AND THE CONTRACTOR SHALL NOTIFY THE CITY FOR REMOVAL AND DISPOSITION OF THE CASTINGS.	RIGHT OF THE CENTERLINE OF PA THE CONTRACTOR WILL DELIVER T BASIS OF PAYMENT:	VEMENT. UPON COMPLETION OF THE WORK, HE RECORD TO THE ENGINEER.
				THE METAL PLATE USED TO COVER THE STRUCTURE SHALL REMAIN THE PROPERTY OF THE CONTRACTOR.	REMOVING FRAMES AND LIDS ON D	RAINAGE AND UTILITY STRUCTURES
				WHEN STRUCTURES ARE TO BE ADJUSTED OR RECONSTRUCTED.	PRIOR TO PLACING THE SURFACE (NG, AND ADJUSTING TO FINAL GRADE COURSE, WILL BE PAID FOR AT THE 'FRAMES AND LIDS TO BE ADJUSTED
				THE LOWERING AND RAISING OF THE FRAMES AND LIDS WILL NOT BE PAID FOR SEPARATELY BUT WILL BE INCLUDED IN THE	(SPECIAL)."	
				COST OF THE CORRESPONDING PAY ITEM.	THIS WORK WILL NOT BE PAID FOF STRUCTURES ARE SPECIFIED FOR F RECONSTRUCTION.	
					NEW FRAMES AND LIDS, WHEN SPEC BE PAID FOR SEPARATELY.	CIFIED, WILL
				DETAILS FOR FRAMES AND LIDS ADJU	JSTMENT	
				WITH MILLING		
	= tballah DESIGNED - KH	REVISED -		DETAILS FOR	ALL DIMENSIONS ARE IN	N INCHES (MILLIMETERS) UNLESS OTHERWISE SECTION NO. COUNTY TOTAL SHEETS
HRGreen.com Minds Professional Design Firm #184-001322 PLOT SCA	DRAWN - KH E = CHECKED - BH	REVISED - REVISED -	STATE OF IL Department of Tra	LINUIS EDAMES AND LIDS AD HISTMENT		19-00098-00-RS DUPAGE 26 CONTRACT NO.
HRGreen.	= 4/16/2021 DATE - 2/3/2021	REVISED -		SCALE: N.T.S. SHEET 1 OF 8 SHEETS STA.	TO STA. FED. ROAD I	DIST. NO. ILLINOIS FED. AID PROJECT

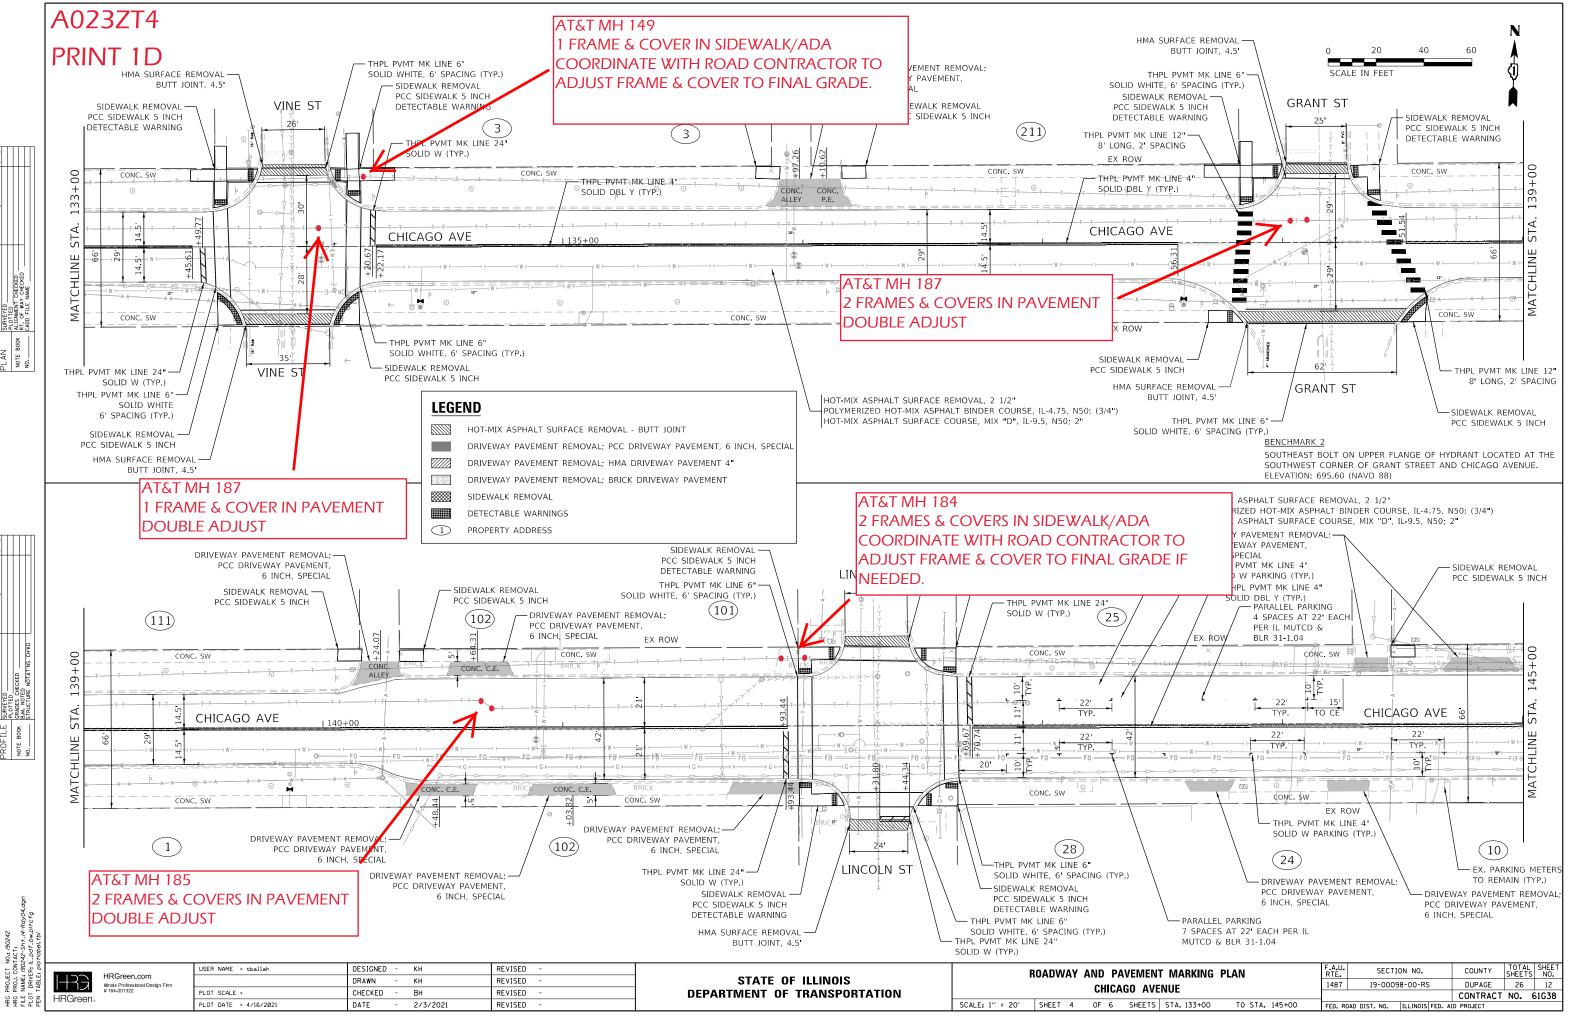
		DET	AILS FO	R		F.A.U. RTE.	SECTION NO.	COUNTY	TOTAL SHEETS	NO.
FRAM	MES AND	LIDS A	DJUSTN	IENT \	NITH MILLING	1487	19-00098-00-RS	DUPAGE	26	15
LE: N.T.S.	SHEET 1	OF 8	SHEETS	STA.	TO STA.	FED. ROAD DI	ST. NO. ILLINOIS FED. A		NO. 0	51G38
LE			FRAMES AND LIDS A	FRAMES AND LIDS ADJUSTN		FRAMES AND LIDS ADJUSTMENT WITH MILLING	DETAILS FOR RTE. FRAMES AND LIDS ADJUSTMENT WITH MILLING	DETAILS FOR RTE. SECTION NO. FRAMES AND LIDS ADJUSTMENT WITH MILLING 1487 19-00098-00-RS	DETAILS FOR RTE. SECTION NO. COUNT FRAMES AND LIDS ADJUSTMENT WITH MILLING 1487 19-00098-00-RS DUPAGE	DETAILS FOR RTE. SECTION NO. COUNT SHEETS FRAMES AND LIDS ADJUSTMENT WITH MILLING 1487 19-00098-00-RS DUPAGE 26

1)	SUB-BASE GRANULAR MATERIAL	(6) FRAME AND LID (SEE NOTES)
2	EXISTING PAVEMENT	CLASS PP-1* CONCRETE
3	36 (900) DIAMETER METAL PLATE	(8) PROPOSED HMA SURFACE COURSE
4	PROPOSED CRUSHED STONE AND HMA SURFACE MIX	-
5	EXISTING STRUCTURE	9 PROPOSED HMA BINDER COURSE

ALL	DIMENSIONS	ARE	IN	INCHES	(MILLIMETERS)	UNLESS	OTHERWISE	SHOWN	
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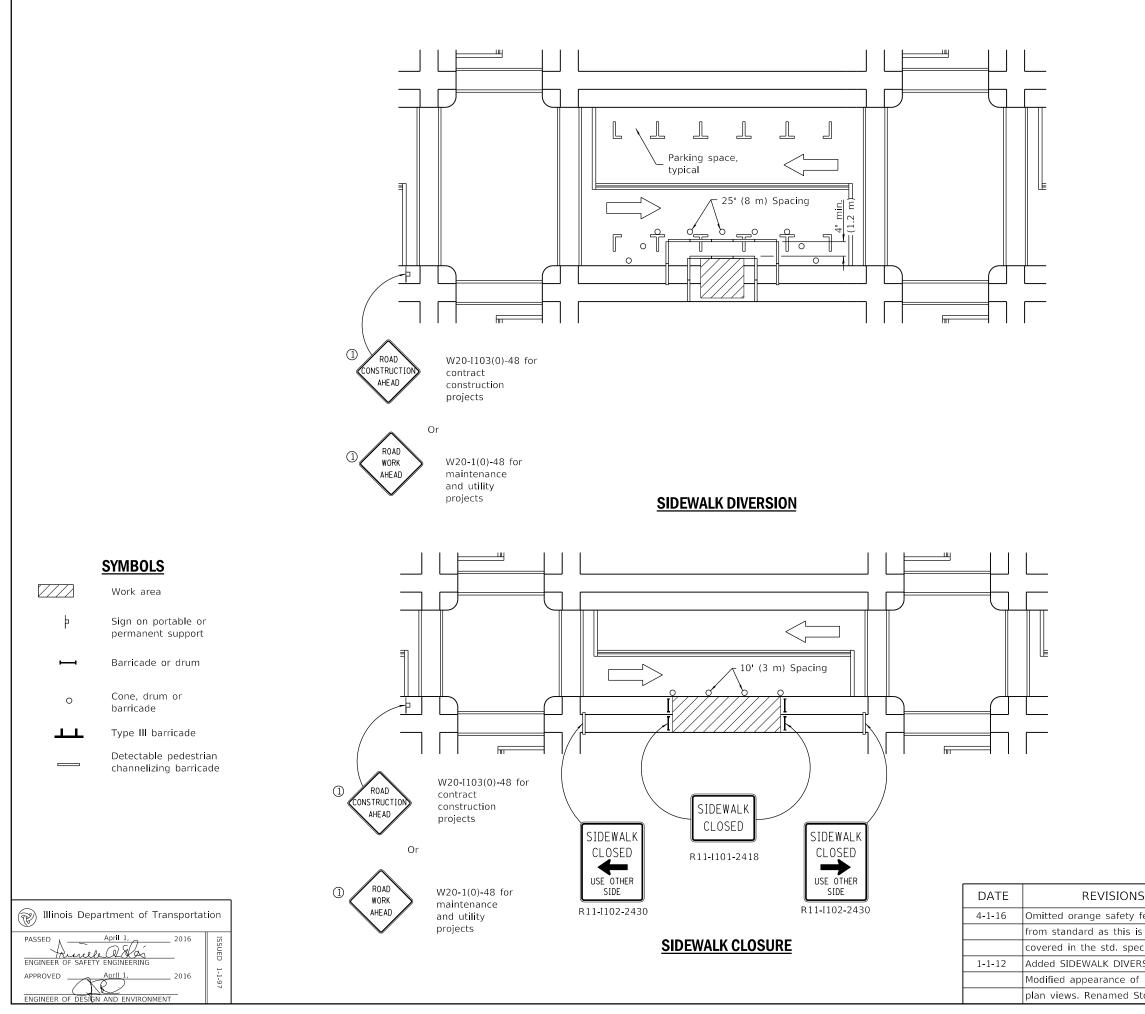
A023ZT4 PRINT 1F				NOTES:	ROAD CONSTRUCTION HEAD * TYPE III BARRICADES WITH TWO FLASHING AMBER LIGHTS ON EACH. (SEE NOTE 2) 200't (60 mt) DRIVEWAY WORK AREA'L	TYPE I OR TYPE II BARRICADES WITH ONE FLASHING AMBER LIGHT ON EACH, OR TYPE III BARRICADES WITH TWO FLASHING AMBER LIGHTS ON EACH, (SEE NOTE 1)
				SHOWN ON THE DRAWING AN a) ONE "ROAD CONSTRUM MOUNTED ON IT APPI	LIMIT OF 40 MPH (60 km/h) OR LESS AS ND AS DIRECTED BY THE ENGINEER: CTION AHEAD" SIGN 36 × 36 (900×900) WITH A FLASHER ROXIMATELY 200' (60 m) IN ADVANCE OF THE MAIN ROUTE.	 5. WHEN WORK IS BEING PERFORMED ON A SIDE ROAD OR DRIVEWAY, FOLLOW THE APPLICABLE STANDARD(S). THE DIRECTIONAL ARROW (M6-1 OR M6-4) SHALL BE COVERED OR REMOVED WHEN NO LONGER CONSISTENT WITH THE TRAFFIC CONTROL SET-UP. 6. ADVANCE WARNING SIGNS ARE TO BE OMITTED ON DRIVEWAYS
				BLOCKING WITH TYPE THE CROSS SECTION 2. SIDE ROAD WITH A SPEED	N OF THE MAIN ROUTE SHALL BE PROTECTED BY I, TYPE II OR TYPE III BARRICADES, 1/3 OF OF THE CLOSED PORTION. LIMIT GREATER THAN 40 MPH (60 km/h) G AND AS DIRECTED BY THE ENGINEER:	UNLESS OTHERWISE SPECIFIED IN THE PLANS OR BY THE ENGINEER. 7. THE TRAFFIC CONTROL AND PROTECTION FOR SIDE ROADS, INTERSECTIONS, AND DRIVEWAYS SHALL BE INCLUDED IN THE COST OF SPECIFIED TRAFFIC CONTROL STANDARDS OR ITEMS.
				FLASHER MOUNTED OI OF THE MAIN ROUTE.		
				BLOCKING WITH TYPE OF THE CLOSED POR		
				SPACING DURING DAY OPER IN HEIGHT.	ED FOR BARRICADES OR DRUMS AT HALF THE RATIONS. CONES SHALL BE A MINIMUM OF 28 (710) BETWEEN THE BEGINNING OF THE MAINLINE	
				SIGNING AND THE WORK ZO	DETWEEN THE BEGINNING OF THE MAINLINE DNE, A SINGLE HEADED ARROW (M6-1) SHALL DOUBLE HEADED ARROW (M6-4).	
04100etr 12-						All dimensions are in inches (millimeters) unless otherwise shown.
HRGreen.com Indepresentational Design Firm # 184-001322 PLOT SCALE =	DRAWN - KH REV CHECKED - BH REV	ISED - ISED - ISED - ISED -	STATE OF II DEPARTMENT OF TR		TRAFFIC CONTROL AND PROTECTION FO SIDE ROADS, INTERSECTIONS, AND DRIVEW SCALE: N.T.S. SHEET 5 OF 8 SHEETS STA.	



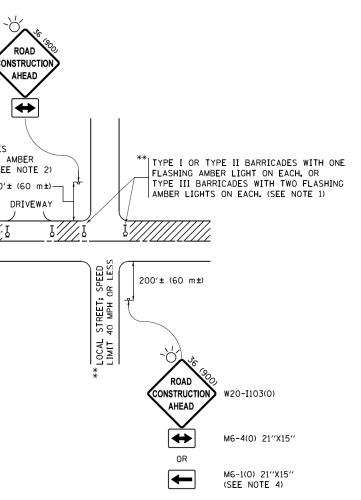

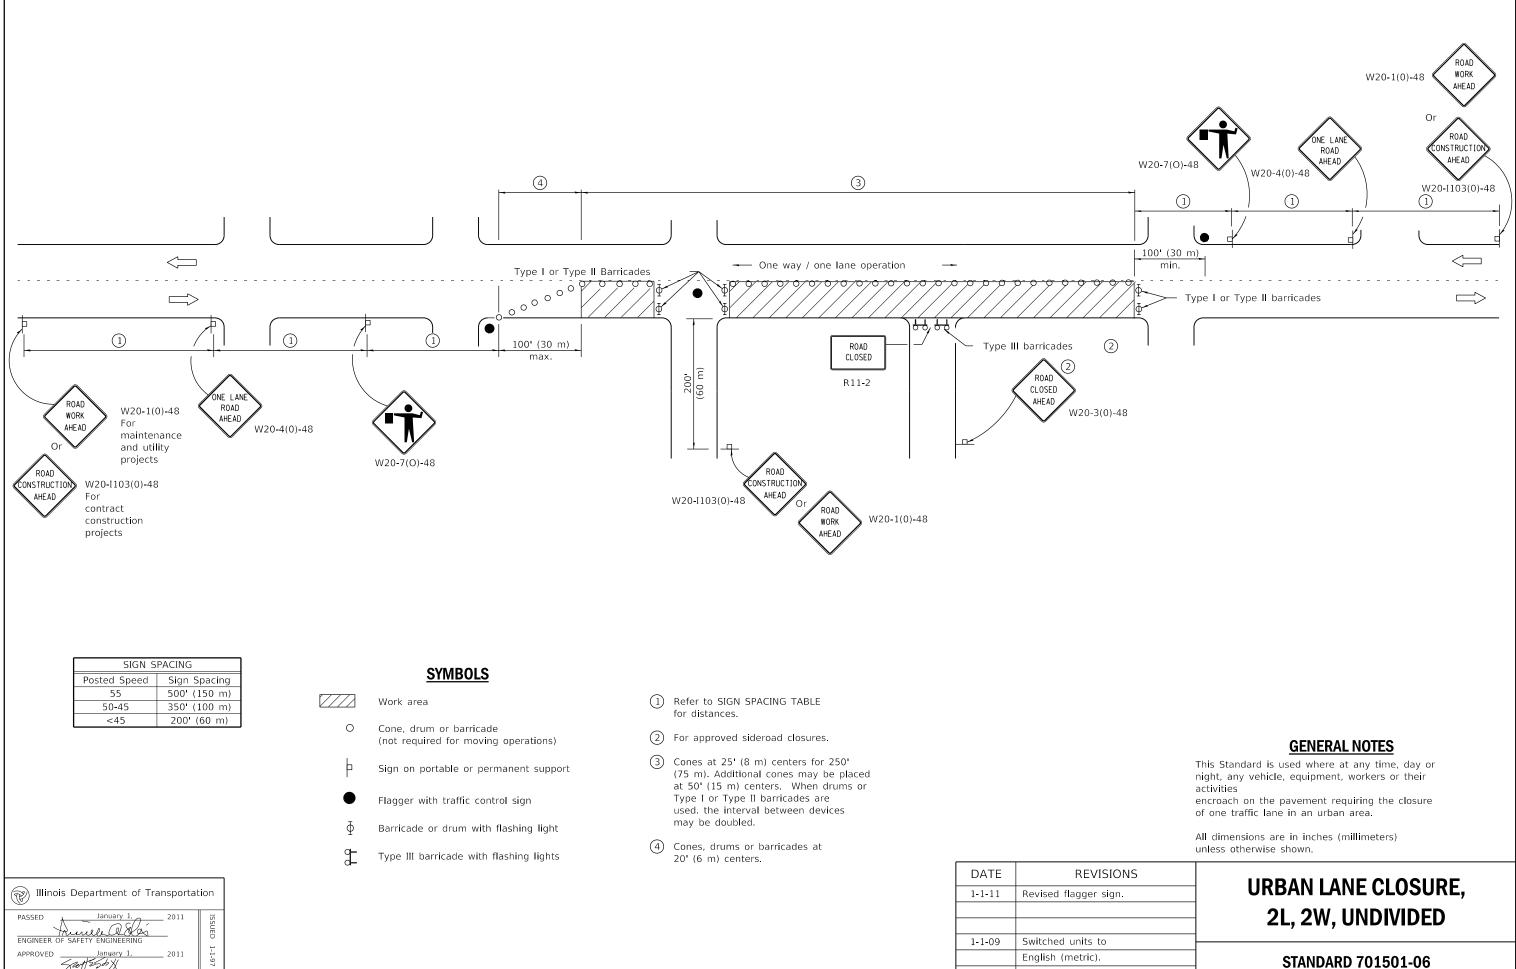ENGINEER OF DESIGN AND EN

STANDARD 701501-06



 Omit whenever duplicated by road work traffic control.

GENERAL NOTES

This Standard is used where, at any time, pedestrian traffic must be rerouted due to work being performed.

This Standard must be used in conjunction with other Traffic Control & Protection Standards when roadway traffic is affected.

Temporary facilities shall be detectable and accessible.

The temporary pedestrian facilities shall be provided on the same side of the closed facilities whenever possible.

The SIDEWALK CLOSED / USE OTHER SIDE sign shall be placed at the nearest crosswalk or intersection to each end of the closure. Where the closure occurs at a corner, the signs shall be erected on the corners across the street from the closure. The SIDEWALK CLOSED signs shall be used at the ends of the actual closures.

Type III barricades and R11-2-4830 signs shall be positioned as shown in "ROAD CLOSED TO ALL TRAFFIC" detail on Standard 701901.


All dimensions are in inches (millimeters) unless otherwise shown.

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SIDEWALK, CORNER OR CROSSWALK CLOSURE

(Sheet 1 of 2)

STANDARD 701801-06

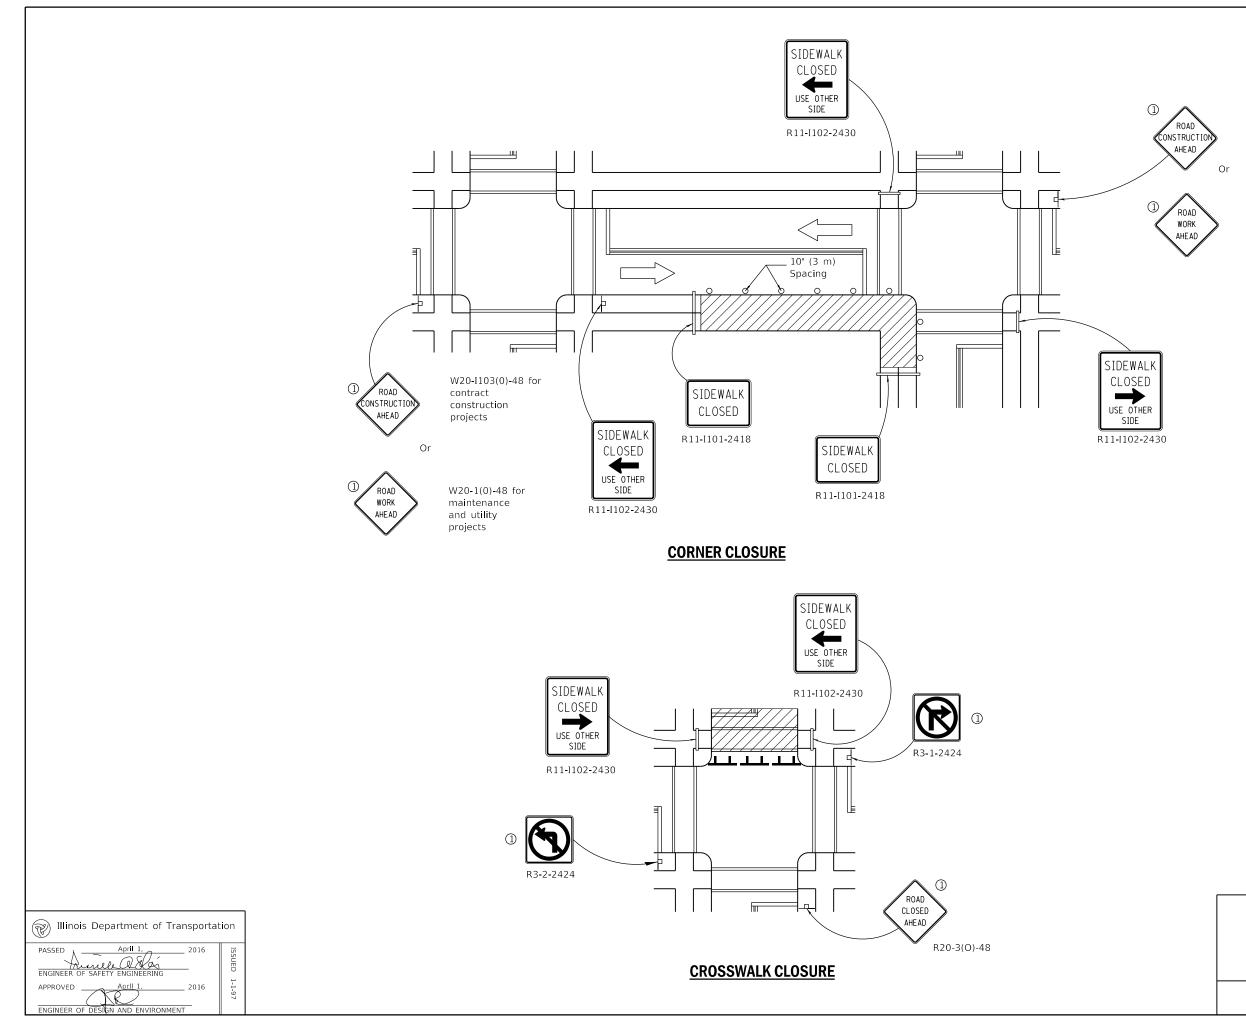


W20-I103(0)-48 for contract construction projects

W20-1(0)-48 for maintenance and utility projects


SIDEWALK, CORNER OR CROSSWALK CLOSURE

(Sheet 2 of 2)

STANDARD 701801-06

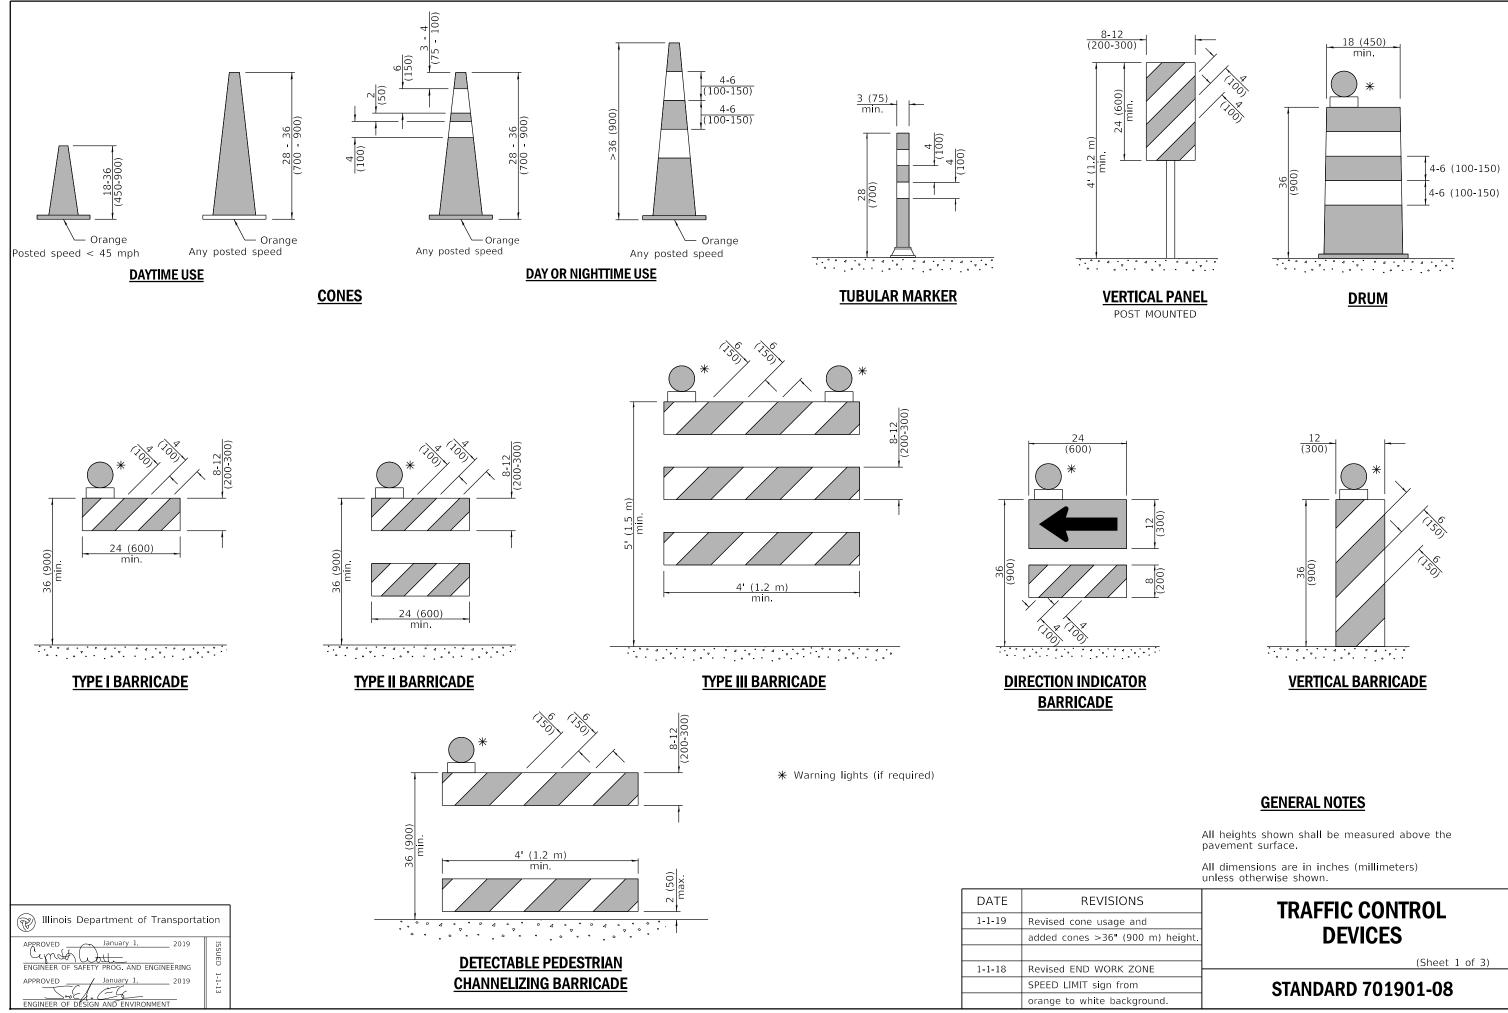

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G20-I104(0)-6036

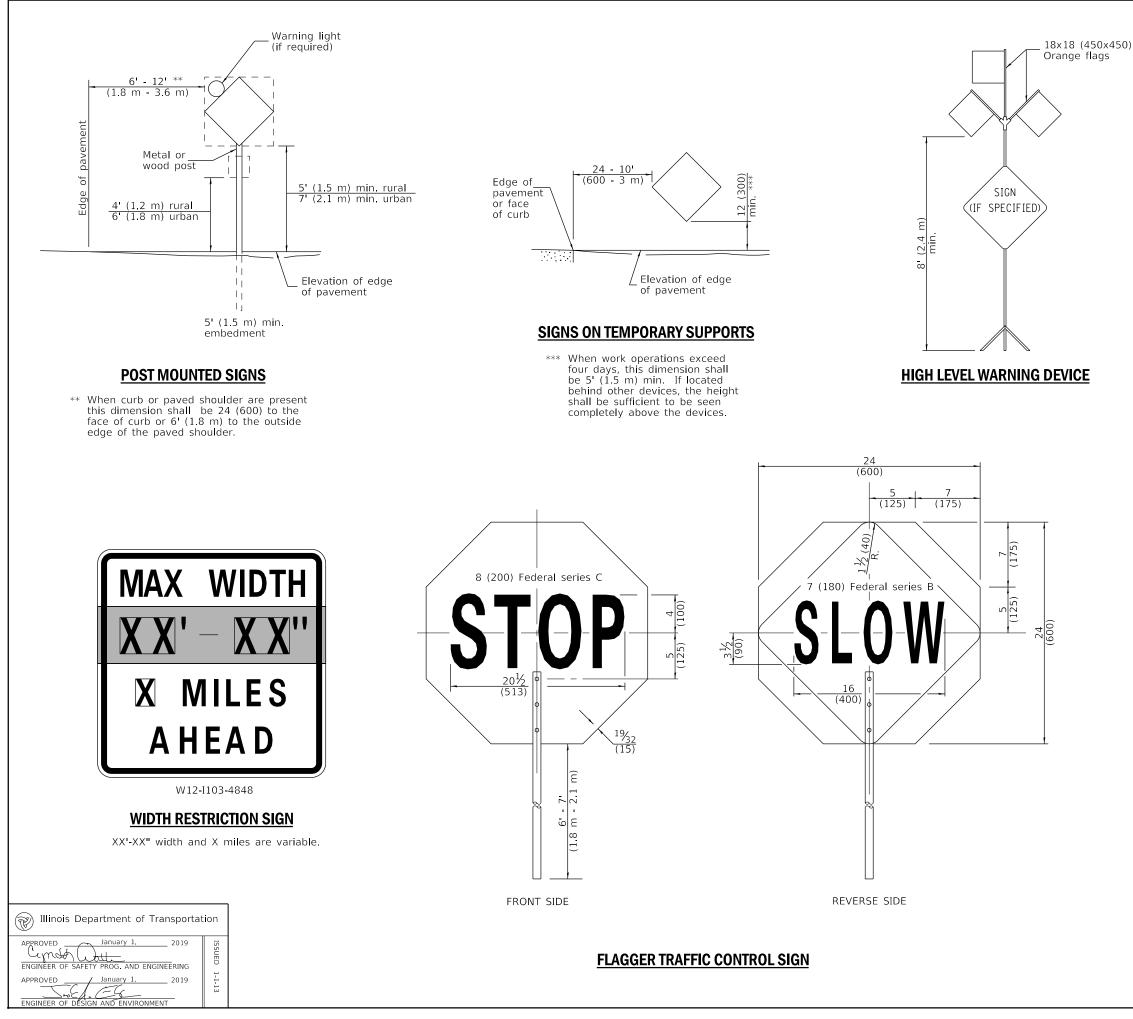G20-I105(0)-6024


This signing is required for all projects 2 miles (3200 m) or more in length.

ROAD CONSTRUCTION NEXT X MILES sign shall be placed 500' (150 m) in advance of project limits.

END CONSTRUCTION sign shall be erected at the end of the job unless another job is within 2 miles (3200 m).

Dual sign displays shall be utilized on multilane highways.

WORK LIMIT SIGNING

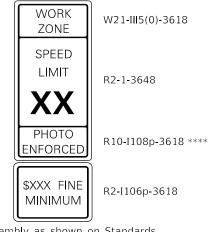

Sign assembly as shown on Standards or as allowed by District Operations.



G20-I103-6036

This sign shall be used when the above sign assembly is used.

HIGHWAY CONSTRUCTION SPEED ZONE SIGNS

**** R10-I108p shall only be used along roadways under the juristiction of the State.

TRAFFIC CONTROL DEVICES

(Sheet 2 of 3)

STANDARD 701901-08

